


Item 5Ai.  
BCWMC 7-20-17

# CONSTRUCTION PLANS FOR PLYMOUTH CREEK STREAM RESTORATION CITY PROJECT NO. 16007

PREPARED FOR  
CITY OF PLYMOUTH, MN

APRIL 2017

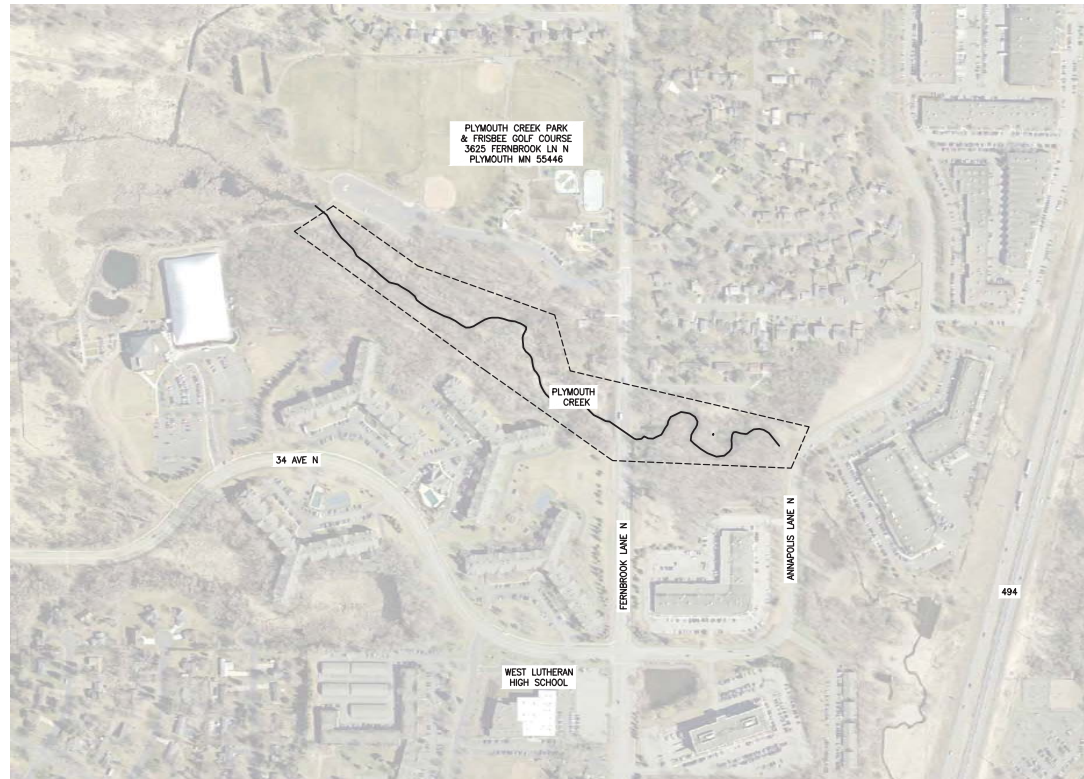

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THIS PLAN CONTAINS 22 SHEETS	

**WARNING:**

THE CONTRACTOR SHALL BE RESPONSIBLE FOR CALLING FOR LOCATIONS OF ALL EXISTING UTILITIES. THEY SHALL COOPERATE WITH ALL UTILITY COMPANIES IN MAINTAINING THEIR SERVICE AND/OR RELOCATION OF LINES.

THE CONTRACTOR SHALL CONTACT GOPHER STATE ONE CALL AT 651-454-0002 AT LEAST 48 HOURS IN ADVANCE FOR THE LOCATIONS OF ALL UNDERGROUND WIRES, CABLES, CONDUITS, PIPES, MANHOLES, VALVES OR OTHER BURIED STRUCTURES BEFORE DIGGING. THE CONTRACTOR SHALL REPAIR OR REPLACE THE ABOVE WHEN DAMAGED DURING CONSTRUCTION AT NO COST TO THE OWNER.

CALL BEFORE YOU DIG  
**GOPHER STATE ONE CALL**  
TWIN CITY AREA: 651-454-0002  
TOLL FREE 1-800-252-1169

**PROJECT VICINITY MAP**

REV	REVISION DESCRIPTION	DWN	APP	REV DATE
1	90% DESIGN	SUB	EAM	06/30/17
0	60% DESIGN	SUB	EAM	04/20/17

SEAL

NOT FOR  
CONSTRUCTION


PRIME CONSULTANT



Responsive partner. Exceptional outcomes.

PROJECT TITLE	PLYMOUTH CREEK CHANNEL RECONSTRUCTION
CITY OF PLYMOUTH	3400 PLYMOUTH BOULEVARD PLYMOUTH, MN 55447

SHEET TITLE		TITLE AND INDEX SHEET	
DWN BY	CHK'D	APP'D	DWG DATE
SUB	LNJ	EAM	MAR 2017
PROJECT NO.	SHEET NO.	SCALE	AS SHOWN
1756-10	G-101		
			REV NO.
			1

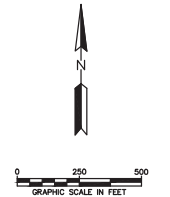

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**GENERAL NOTES:**

- EXISTING CONDITIONS HAVE BEEN PROVIDED BY A COMBINATION OF HISTORIC PLANS FROM THE CITY, SURVEY INFORMATION FROM A SITE VISIT BY WENCK STAFF AND LEAD. EXISTING FEATURES MAY NOT BE EXACT TO THEIR LOCATION. THE CONTRACTOR IS RESPONSIBLE FOR VERIFYING THE CONDITIONS OF THE SITE AND SHALL NOTIFY THE ENGINEER OF ANY DISCREPANCIES OR VARIATIONS FROM THE DRAWINGS.
- ALL QUANTITIES ARE APPROXIMATE AND MAY VARY TO ALLOW COMPLETION OF WORK.
- THE SUBSURFACE UTILITY INFORMATION IN THIS PLAN IS UTILITY QUALITY LEVEL D. THIS QUALITY LEVEL WAS DETERMINED ACCORDING TO THE GUIDELINES OF CI/ASCE 38-2 ENTITLED "STANDARD GUIDELINES FOR THE COLLECTION AND DEPICTION OF EXISTING SUBSURFACE UTILITY DATA".
- EXACT LOCATION OF UNDERGROUND UTILITIES SUCH AS GAS, TELEPHONE, FIBER OPTIC, PIPELINES, ELECTRICAL, AND CABLE TV ARE UNKNOWN. CONTRACTOR RESPONSIBLE FOR LOCATING PRIOR TO STARTING WORK.
- CONTRACTOR SHOULD ANTICIPATE PRIVATE UTILITY CONFLICTS THROUGHOUT THE PROJECT SUB CUT AND TRENCH AREAS AND SHALL COORDINATE WITH PRIVATE UTILITY OWNERS.
- THE RELOCATION AND OR PROTECTION OF ALL EXISTING UTILITIES MUST BE COORDINATED BY THE CONTRACTOR AND ANY COSTS FOR SUCH WORK SHALL BE THE RESPONSIBILITY OF THE CONTRACTOR. NO ADDITIONAL COMPENSATION WILL BE ALLOWED FOR EXTRA TIME AND EFFORT OF PROVISIONS NECESSARY TO WORK AROUND OR UNDER ANY UTILITIES.
- INSTALL AND MAINTAIN EROSION CONTROL DEVICES AS SPECIFIED OR AS DIRECTED BY ENGINEER.
- CONTRACTOR SHALL COMPLY WITH ALL STATE, COUNTY, AND CITY PERMITS.
- MAINTAIN MAINT, GARBAGE, AND RECYCLING SERVICES TO PROPERTIES.
- PROTECT EXISTING PAVEMENT AND SITE FEATURES, EXCEPT AS NOTED.
- CONTRACTOR TO COORDINATE AND MAINTAIN ACCESS TO PROPERTIES.
- MAINTAIN DRAINAGE CONVEYANCE DURING CONSTRUCTION (BOTH PIPED AND OVERLAND).
- THE EXISTING PAVEMENT CONDITIONS HAVE BEEN DOCUMENTED, AND ANY DAMAGE TO THE EXISTING PAVEMENT, CURBING, AND STRIPING SHALL BE REPLACED BY THE CONTRACTOR, TO THE OWNERS SATISFACTION, AT NO ADDITIONAL COST TO THE OWNER.

**REMOVAL NOTES:**

- FEATURES NOT SPECIFICALLY IDENTIFIED ON PLAN FOR SALVAGE OR REMOVAL THAT CONFLICT WITH CONSTRUCTION ARE TO BE REVIEWED WITH ENGINEER.

**DEWATERING NOTES:**

- NO BID ITEM HAS BEEN PROVIDED FOR DEWATERING AS ALL DEWATERING WORK NECESSARY FOR CONSTRUCTION WILL BE CONSIDERED INCIDENTAL.
- ENERGY DISSIPATION SHALL BE PROVIDED AT ALL DISCHARGE POINTS TO PREVENT SCOUR.
- PROVIDE SILT BAGS FOR DEWATERING.
- CONTRACTOR RESPONSIBLE TO SUBMIT DEWATERING PLAN TO ENGINEER FOR REVIEW. DEWATERING SHALL MEET ALL PERMIT REQUIREMENTS AND BE APPROVED PRIOR TO STARTING ANY CONSTRUCTION ACTIVITIES.
- THE CONTRACTOR MUST DISCHARGE TURBID OR SEDIMENT-LADEN WATER RELATED TO DEWATERING OR BASIN DRAINING (E.G. PUMPED DISCHARGES, TRENCH/DITCH CUTS FOR DRAINAGE) TO A TEMPORARY OR PERMANENT SEDIMENTATION BASIN ON THE PROJECT SITE UNLESS INFASIBLE. THE CONTRACTOR MAY DISCHARGE FROM THE TEMPORARY OR PERMANENT SEDIMENTATION BASINS TO THE SURFACE WATERS IF THE BASIN WATER HAS BEEN VISUALLY CHECKED TO ENSURE ADEQUATE TREATMENT HAS BEEN OBTAINED IN THE BASIN AND THAT NUISANCE CONDITIONS (SEE MINN. RULES 7050.0210, SUBPART 2) WILL NOT RESULT FROM THE DISCHARGE. IF THE WATER CANNOT BE DISCHARGED TO A SEDIMENTATION BASIN PRIOR TO ENTERING THE SURFACE WATER, IT MUST BE TREATED WITH THE APPROPRIATE BMPs, SUCH THAT THE DISCHARGE DOES NOT ADVERSELY AFFECT THE RECEIVING WATER OR DOWNSTREAM PROPERTIES. IF THE CONTRACTOR MUST DISCHARGE WATER THAT CONTAINS OIL OR GREASE, THE CONTRACTOR MUST USE AN OIL-WATER SEPARATOR OR SUITABLE FILTRATION DEVICE (E.G. CARTRIDGE FILTERS, ADSORBENT PADS) PRIOR TO DISCHARGING THE WATER. THE CONTRACTOR MUST ENSURE THAT DISCHARGE POINTS ARE ADEQUATELY PROTECTED FROM EROSION AND SCOUR. THE DISCHARGE MUST BE DISPERSED OVER NATURAL ROCK RIPRAP, SAND BAGS, PLASTIC SHEETING, OR OTHER ACCEPTED ENERGY DISSIPATION MEASURES.
- ALL WATER FROM DEWATERING OR BASIN-DRAINING ACTIVITIES MUST BE DISCHARGED IN A MANNER THAT DOES NOT CAUSE NUISANCE CONDITIONS, EROSION IN RECEIVING CHANNELS OR ON DOWNSLOPE PROPERTIES, OR INUNDATION IN WETLANDS CAUSING SIGNIFICANT ADVERSE IMPACT TO THE WETLAND.
- IF THE CONTRACTOR IS USING FILTERS WITH BACKWASH WATER, THE CONTRACTOR MUST HAUL THE BACKWASH WATER AWAY FOR DISPOSAL, RETURN THE BACKWASH WATER TO THE BEGINNING OF THE TREATMENT PROCESS, OR INCORPORATE THE BACKWASH WATER INTO THE SITE IN A MANNER THAT DOES NOT CAUSE EROSION. THE CONTRACTOR MAY DISCHARGE BACKWASH WATER TO THE SANITARY SEWER IF PERMISSION IS GRANTED BY THE SANITARY SEWER AUTHORITY. THE CONTRACTOR MUST REPLACE AND CLEAN THE FILTER MEDIA USED IN DEWATERING DEVICES WHEN REQUIRED TO RETAIN ADEQUATE FUNCTION.

**WARNING:**

THE CONTRACTOR SHALL BE RESPONSIBLE FOR CALLING FOR LOCATIONS OF ALL EXISTING UTILITIES. THEY SHALL COOPERATE WITH ALL UTILITY COMPANIES IN MAINTAINING THEIR SERVICE AND/OR RELOCATION OF LINES.  
 THE CONTRACTOR SHALL CONTACT GOPHER STATE ONE CALL AT 651-454-0002 AT LEAST 48 HOURS IN ADVANCE FOR THE LOCATIONS OF ALL UNDERGROUND WRES, CABLES, CONDUITS, PIPES, MANHOLES, VALVES OR OTHER BURIED STRUCTURES BEFORE DIGGING. THE CONTRACTOR SHALL REPAIR OR REPLACE THE ABOVE WHEN DAMAGED DURING CONSTRUCTION AT NO COST TO THE OWNER.

**CALL BEFORE YOU DIG  
 GOPHER STATE ONE CALL**

TWIN CITY AREA: 651-454-0002  
 TOLL FREE 1-800-252-1166

**GOVERNING SPECIFICATIONS:**

- THE MINNESOTA DEPARTMENT OF TRANSPORTATION "STANDARD SPECIFICATIONS FOR CONSTRUCTION" 2016 EDITION & LATEST SUPPLEMENTS.
- CITY ENGINEERS ASSOCIATION OF MINNESOTA (CEAM) STANDARD UTILITIES SPECIFICATIONS (LATEST EDITION)
- CITY OF PLYMOUTH CONSTRUCTION SPECIFICATIONS
- ALL APPLICABLE FEDERAL, STATE AND LOCAL LAWS AND ORDINANCE WILL BE COMPLETED WITH IN THE CONSTRUCTION OF THIS PROJECT.

**TRAFFIC CONTROL NOTES:**

- THE CONTRACTOR SHALL BE RESPONSIBLE FOR COORDINATING ALL CONSTRUCTION STAGING, ON OR OFFSITE, AS NECESSARY TO COMPLETE THE WORK AS SPECIFIED IN THE PROJECT DOCUMENTS. A STAGING PLAN SHALL BE SUBMITTED TO THE ENGINEER FOR REVIEW AND APPROVAL PRIOR TO ANY CONSTRUCTION RELATED ACTIVITIES.
- CONTRACTOR SHALL BE RESPONSIBLE FOR ALL TRAFFIC CONTROL. ALL TRAFFIC CONTROL SHALL CONFORM TO THE LATEST EDITION OF THE MUTCD, INCLUDING THE LATEST FIELD MANUAL FOR TEMPORARY TRAFFIC CONTROL ZONE LAYOUTS. A TRAFFIC CONTROL PLAN SHALL BE SUBMITTED TO THE ENGINEER, CITY, AND COUNTY FOR REVIEW AND APPROVAL PRIOR TO ANY CONSTRUCTION RELATED ACTIVITIES. PLANS SHALL COMPLY WITH ALL APPLICABLE PERMIT REQUIREMENTS.
- TRAFFIC CONTROL SHALL ALSO INCLUDE ALL NECESSARY SIGNAGE AND MARKINGS REQUIRED FOR THE BOARDWALK CLOSURE (SIMILAR TO SIDEWALK CLOSURE). THIS SHALL INCLUDE ADVANCED WARNING SIGNS AND NECESSARY FENCING AND SIGNAGE TO PREVENT PEDESTRIANS FROM ACCESSING THE PROPOSED BOARDWALK CONNECTION AREA.

**EROSION CONTROL NOTES:**

- SEE SHEETS EC-101, EC-102, EC-103, EC-104 FOR EROSION AND SEDIMENT CONTROL MEASURES.
- ADDITIONAL EROSION CONTROL MEASURES MAY BE REQUIRED DEPENDING ON SITE CONDITIONS DURING CONSTRUCTION. COORDINATE WITH ENGINEER.
- CONCRETE WASH-OUT SHALL COMPLETED OFF-SITE OR CONCRETE READY MIX TRUCKS SHALL BE SELF-CONTAINED.
- ALL EROSION CONTROL DEVICES TO BE INSTALLED PRIOR TO COMMENCEMENT OF WORK, MAINTAINED IN ACCORDANCE WITH THE SWPPP, NOTES, AND SPECIFICATIONS THROUGHOUT DURATION OF PROJECT, AND REMOVED UPON ESTABLISHMENT OF FINAL STABILIZATION AS DIRECTED BY ENGINEER. EROSION CONTROL MEASURES USED FOR CONSTRUCTION SHALL NOT BE REMOVED UNTIL AUTHORIZED BY OWNER OR ENGINEER.
- REMOVE TRACKED SEDIMENT FROM ALL PAVED SURFACES BOTH ON AND OFFSITE ON A DAILY BASIS (INCIDENTAL).
- MINIMIZE DUST FROM CONSTRUCTION OPERATIONS BY PROVIDING WATER OR OTHER APPROVED METHOD ON A DAILY BASIS (INCIDENTAL).

**HORIZONTAL AND VERTICAL CONTROL:**

- THE HORIZONTAL CONTROL FOR THIS PLAN IS HENNEPIN COUNTY COORDINATE RELATIVE TO SYSTEM NAD83(11).
- THE VERTICAL CONTROL FOR THIS PLAN IS NAVD88.

**ABBREVIATIONS**

- BV BUTTERFLY VALVE
- CL CENTER LINE
- CL CLASS
- CMP CORRUGATE METAL PIPE
- CY CUBIC YARD
- DIP DUCTILE IRON PIPE
- EL/ELEV ELEVATION
- EX EXISTING
- FES FLARED END SECTION
- F/F FACE TO FACE
- FM FORCEMAN
- GV GATE VALVE
- HDPE HIGH-DENSITY POLYETHYLENE
- HP HIGH POINT
- HWL HIGH WATER LEVEL
- HYD HYDRANT
- INV INVERT
- LF LINEAL FEET
- LP LOW POINT
- MH MANHOLE
- NWL NORMAL WATER LEVEL
- PVC POLYVINYL CHLORIDE
- R RADIUS
- RCP REINFORCED CONCRETE PIPE
- R/W RIGHT-OF-WAY
- SF SQUARE FEET
- STA STATION
- SY SQUARE YARD
- TNH TOP NUT HYDRANT
- TYP TYPICAL
- WM WATERMAIN

**EXISTING SYMBOLS/LINES LEGEND**

- STORM SEWER FLARED END SECTION
- STORM SEWER CATCH BASIN/MANHOLE
- STORM SEWER
- HYDRANT
- WATER MAIN
- CONTOUR MINOR
- CONTOUR MAJOR
- PROPERTY LINE
- PROJECT AREA LIMITS
- ACCESS ROUTE BOUNDARY
- RETAINING WALL
- EXISTING FENCE
- EXISTING CHANNEL
- APPROXIMATE TREE LINE
- WETLAND BOUNDARY
- DECIDUOUS TREE
- UTILITY POLE
- LIGHT POLE
- EDGE OF PAVEMENT
- SIGN
- MAILBOX
- GUARD POST
- PROPERTY IRON

**PROPOSED SYMBOLS/LINES LEGEND**

- RIP RAP
- STORM SEWER CATCH BASIN/MANHOLE
- STORM SEWER
- DRAIN TILE
- VEGETATED RIPRAP
- TWO STAGE CHANNEL
- CHANNEL CLEANOUT
- GRADED BANK
- CONTOUR MINOR
- CONTOUR MAJOR
- SPOT ELEVATION
- BITUMINOUS
- CONCRETE
- DECIDUOUS TREE
- ACCESS ROUTE BOUNDARY
- EXISTING FENCE
- PROPERTY LINE
- ROOTWAD WITH STONE TOE
- WATER EDGE
- PROPOSED CHANNEL CENTERLINE
- PROJECT AREA LIMITS
- ROOTWAD WITH LOG TOE
- VEGETATED RIPRAP TOE
- BARE ROOT SHRUB PLANTING

**REMOVAL SYMBOLS/LINES LEGEND**

- TREE REMOVAL

**EROSION CONTROL SYMBOLS/LINES LEGEND**

- STRAW MULCH W/ DISK ANCHORING AND MN SEED MIX 34-262
- EROSION CONTROL BLANKET AND MN SEED MIX 34-262
- SILT FENCE
- FLOTATION SILT CURTAIN
- INLET PROTECTION
- BIOROLL

REV	REVISION DESCRIPTION	DWN	APP	REV DATE
1	90% DESIGN	SUB	EAM	06/30/17
0	60% DESIGN	SUB	EAM	04/20/17

SEAL

NOT FOR CONSTRUCTION

PRIME CONSULTANT



PROJECT TITLE

PLYMOUTH CREEK CHANNEL RECONSTRUCTION

CITY OF PLYMOUTH


3400 PLYMOUTH BOULEVARD  
 PLYMOUTH, MN 55447

SHEET TITLE

LEGEND AND GENERAL NOTES

DWN BY: SUB, CHK'D: LNJ, APP'D: EAM, DWG DATE: MAR 2017, SCALE: AS SHOWN

PROJECT NO.: 1756-10, SHEET NO.: G-102, REV NO.: 1

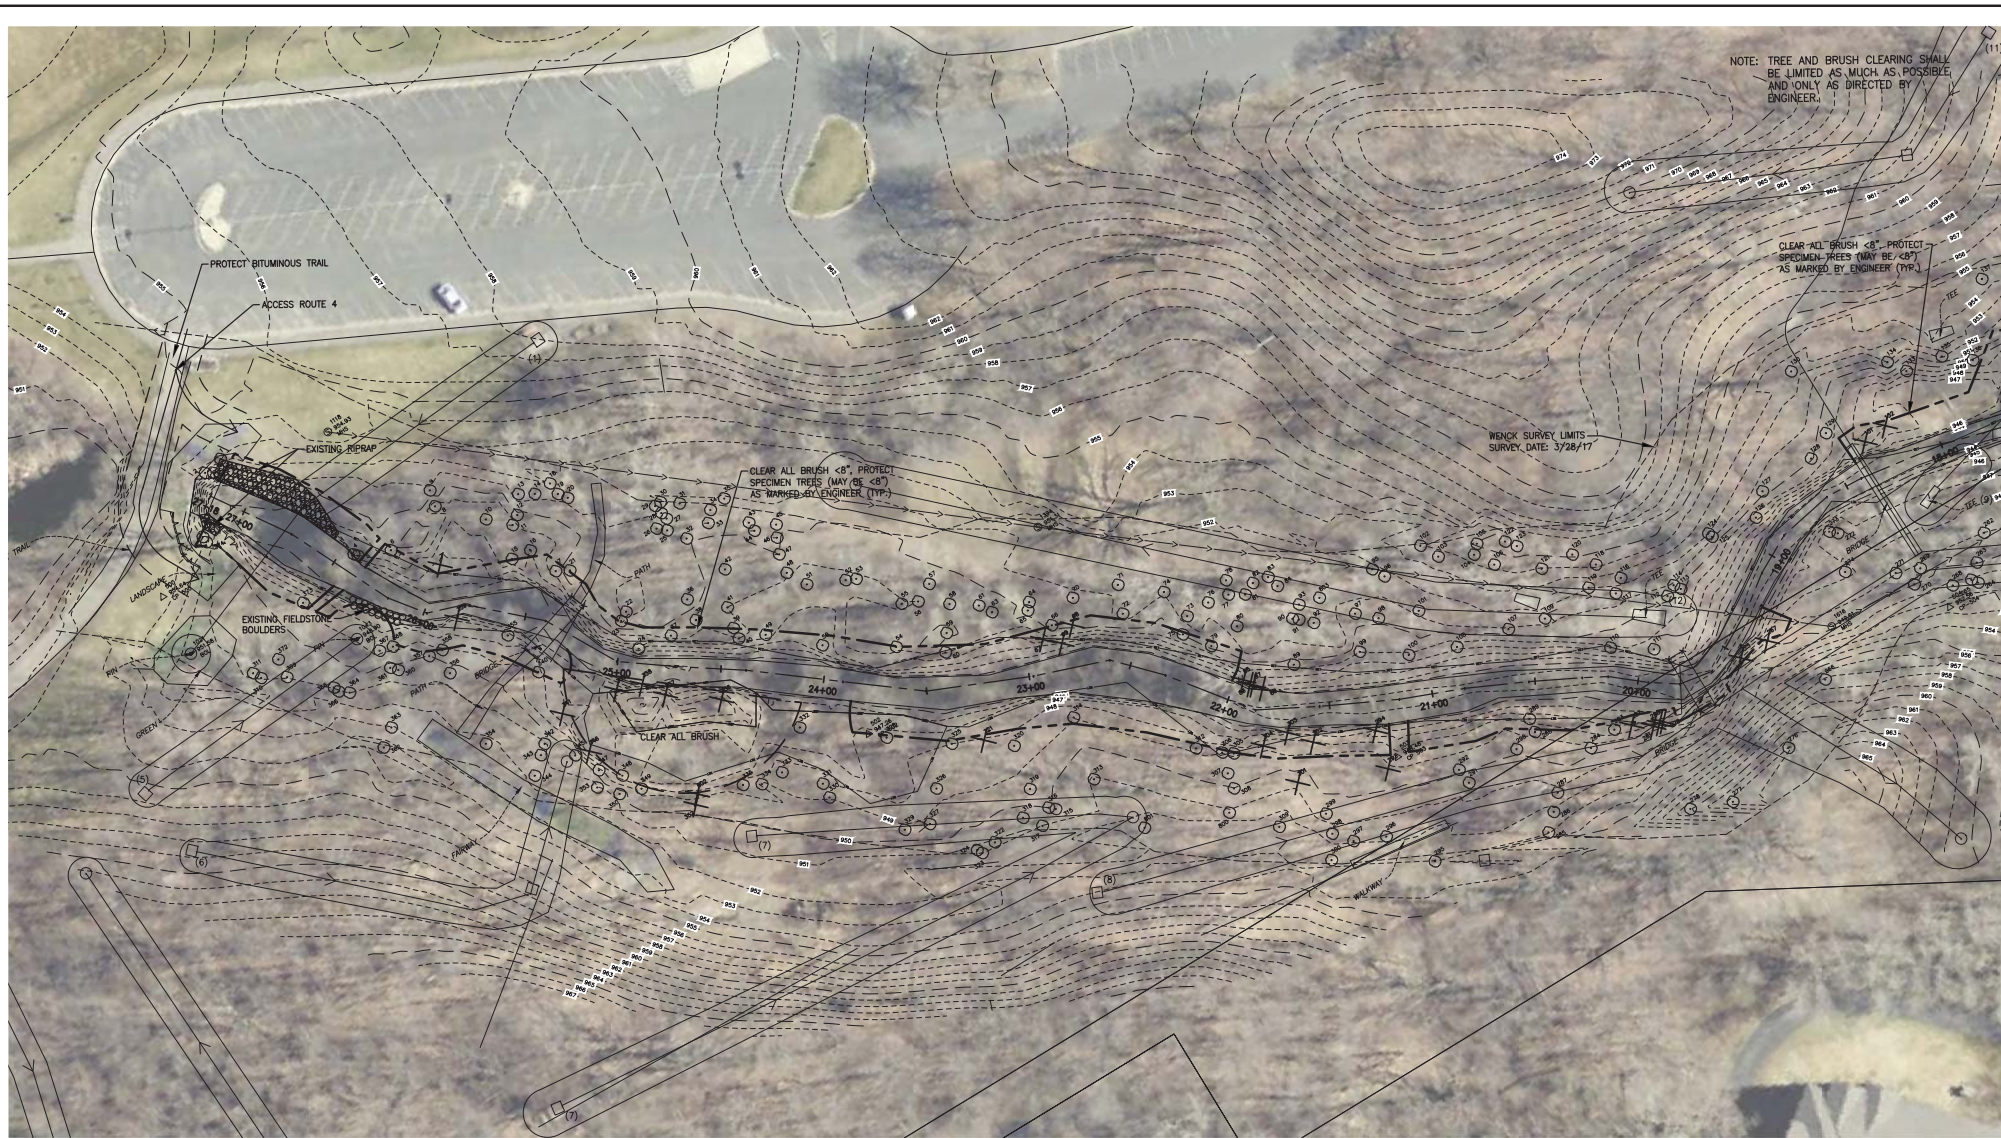

NOTE: TREE AND BRUSH CLEARING SHALL BE LIMITED AS MUCH AS POSSIBLE AND ONLY AS DIRECTED BY ENGINEER.

CLEAR ALL BRUSH <8" PROTECT SPECIMEN TREES (MAY BE <8" AS MARKED BY ENGINEER (TYP))


CLEAR ALL BRUSH <8" PROTECT SPECIMEN TREES (MAY BE <8" AS MARKED BY ENGINEER (TYP))

CLEAR ALL BRUSH

**LEGEND**

	DECIDUOUS TREE/REMOVAL		WATER EDGE
	ACCESS ROUTE BOUNDARY		RETAINING WALL
	EXISTING FENCE		PROPOSED CHANNEL CENTERLINE
	PROPERTY LINE		PROJECT AREA LIMITS
	ROADWAY WITH STONE TOE		ROADWAY WITH LOG TOE
			VEGETATED RIPRAP TOE

	WATER EDGE
	RETAINING WALL
	PROPOSED CHANNEL CENTERLINE
	PROJECT AREA LIMITS
	ROADWAY WITH LOG TOE
	VEGETATED RIPRAP TOE

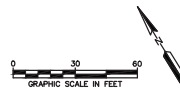

REV	REVISION DESCRIPTION	DWN	APP	REV DATE
1	90% DESIGN	SUB	EAM	06/30/17
0	60% DESIGN	SUB	EAM	04/20/17

SEAL

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PRIME CONSULTANT

Responsive partner. Exceptional outcomes.

PROJECT TITLE  
**PLYMOUTH CREEK CHANNEL RECONSTRUCTION**

CITY OF PLYMOUTH

3400 PLYMOUTH BOULEVARD  
 PLYMOUTH, MN 55447

SHEET TITLE


**EXISTING CONDITIONS AND REMOVALS 27+18 TO 18+00**

DWN BY	CHK'D	APP'D	DWG DATE	MAR 2017
SUB	LNJ	EAM	SCALE	AS SHOWN
PROJECT NO.	SHEET NO.	REV NO.		
1756-10	C-101	1		



**LEGEND**


	WATER EDGE
	RETAINING WALL
	PROPOSED CHANNEL CENTERLINE
	PROJECT AREA LIMITS
	ROOTWAD WITH LOG TOE
	VEGETATED RIPRAP TOE

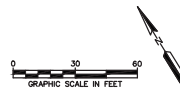

REV	REVISION DESCRIPTION	DWN	APP	REV DATE
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0	60% DESIGN	SUB	EAM	04/20/17

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PROJECT TITLE  
**PLYMOUTH CREEK CHANNEL RECONSTRUCTION**

CITY OF PLYMOUTH

3400 PLYMOUTH BOULEVARD  
 PLYMOUTH, MN 55447

SHEET TITLE			
<b>EXISTING CONDITIONS AND REMOVALS 18+00 TO 9+00</b>			
DWN BY SJB	CHK'D LNJ	APP'D EAM	DWG DATE MAR 2017
PROJECT NO. 1756-10	SHEET NO. C-102	SCALE AS SHOWN	REV NO. 1




NOTE: TREE AND BRUSH CLEARING SHALL BE LIMITED AS MUCH AS POSSIBLE AND ONLY AS DIRECTED BY ENGINEER.

NOTE: WOODY MATERIAL IN THE CHANNEL ON THIS REACH OF THE PROJECT SHALL BE REMOVED BY THE CONTRACTOR.

**LEGEND**

	DECIDUOUS TREE/REMOVAL		WATER EDGE
	ACCESS ROUTE BOUNDARY		RETAINING WALL
	EXISTING FENCE		PROPOSED CHANNEL CENTERLINE
	PROPERTY LINE		PROJECT AREA LIMITS
	ROOTWAD WITH STONE TOE		ROOTWAD WITH LOG TOE
	RIPRAP TOE		VEGETATED RIPRAP TOE

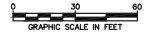

REV	REVISION DESCRIPTION	DWN	APP	REV DATE
1	90% DESIGN	SUB	EAM	06/30/17
0	60% DESIGN	SUB	EAM	04/20/17

SEAL

**NOT FOR CONSTRUCTION**

PRIME CONSULTANT

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PROJECT TITLE  
**PLYMOUTH CREEK CHANNEL RECONSTRUCTION**

CITY OF PLYMOUTH

3400 PLYMOUTH BOULEVARD  
 PLYMOUTH, MN 55447


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**EXISTING CONDITIONS AND REMOVALS 9+00 TO 0+00**

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SUB	LNJ	EAM	SCALE	AS SHOWN
PROJECT NO.	SHEET NO.	SHEET NO.		REV NO.
1756-10	C-103			1




PLYMOUTH CREEK CENTERLINE STA 27+18 TO 18+00

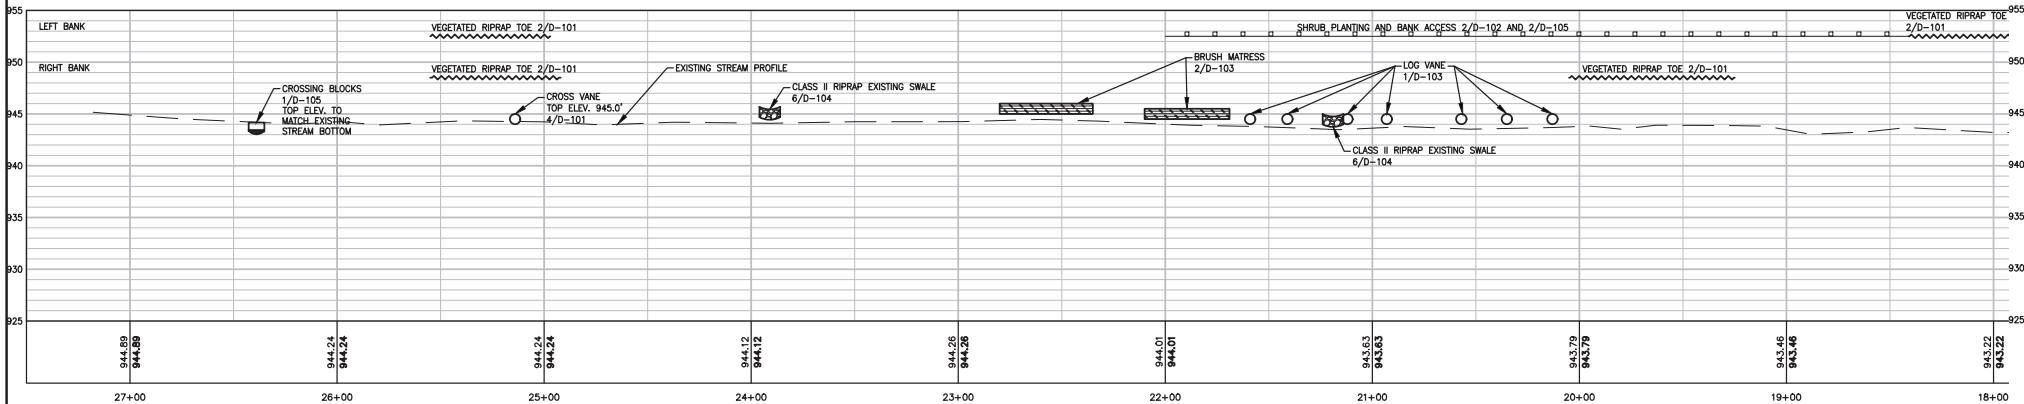

**LEGEND**

	DECIDUOUS TREE		WATER EDGE
	ACCESS ROUTE BOUNDARY		RETAINING WALL
	EXISTING FENCE		PROPOSED CHANNEL CENTERLINE
	PROPERTY LINE		PROJECT AREA LIMITS
	ROOTWAD WITH STONE TOE		ROOTWAD WITH LOG TOE
	BARE ROOT SHRUB PLANTING		VEGETATED RIPRAP TOE
	SHRUB PLANTING WITH BANK ACCESS		

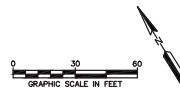

REV	REVISION DESCRIPTION	DWN	APP	REV DATE
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0	60% DESIGN	SUB	EAM	04/20/17

NOT FOR CONSTRUCTION

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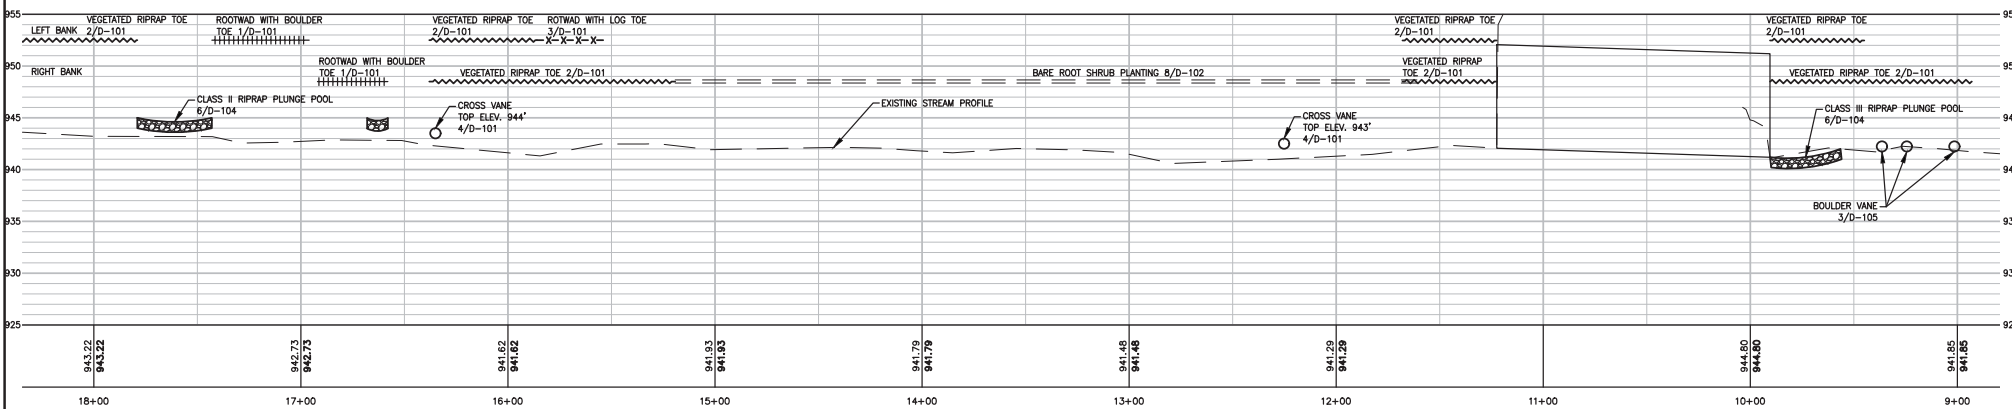
PROJECT TITLE	
PLYMOUTH CREEK CHANNEL RECONSTRUCTION	
CITY OF PLYMOUTH	
3400 PLYMOUTH BOULEVARD PLYMOUTH, MN 55447	

SHEET TITLE			
STABILIZATION PLAN AND PROFILE 27+18 TO 18+00			
DWN BY	CHK'D	APP'D	DWG DATE
SUB	LNJ	EAM	MAR 2017
PROJECT NO.		SCALE	AS SHOWN
1756-10		C-104	REV NO.
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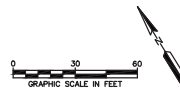


PLYMOUTH CREEK CENTERLINE STA 18+00 TO 9+00



**LEGEND**

	DECIDUOUS TREE		WATER EDGE
	ACCESS ROUTE BOUNDARY		RETAINING WALL
	PROPOSED CHANNEL CENTERLINE		PROJECT AREA LIMITS
	EXISTING FENCE		ROOTWAD WITH STONE TOE
	PROPERTY LINE		ROOTWAD WITH LOG TOE
	ROOTWAD WITH BOULDER TOE		VEGETATED RIPRAP TOE
	ROOTWAD WITH LOG TOE		
	BARE ROOT SHRUB PLANTING		
	SHRUB PLANTING WITH BANK ACCESS		



REV	REVISION DESCRIPTION	DWN	APP	REV DATE
1	90% DESIGN	SUB	EAM	06/30/17
0	60% DESIGN	SUB	EAM	04/20/17

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 PLYMOUTH CREEK CHANNEL RECONSTRUCTION



CITY OF PLYMOUTH  
 3400 PLYMOUTH BOULEVARD  
 PLYMOUTH, MN 55447

SHEET TITLE  
 STABILIZATION PLAN AND PROFILE 18+00 TO 9+00


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SUB	LNJ	EAM	SCALE	AS SHOWN

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 REV NO. 1

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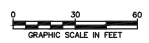


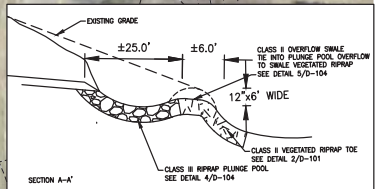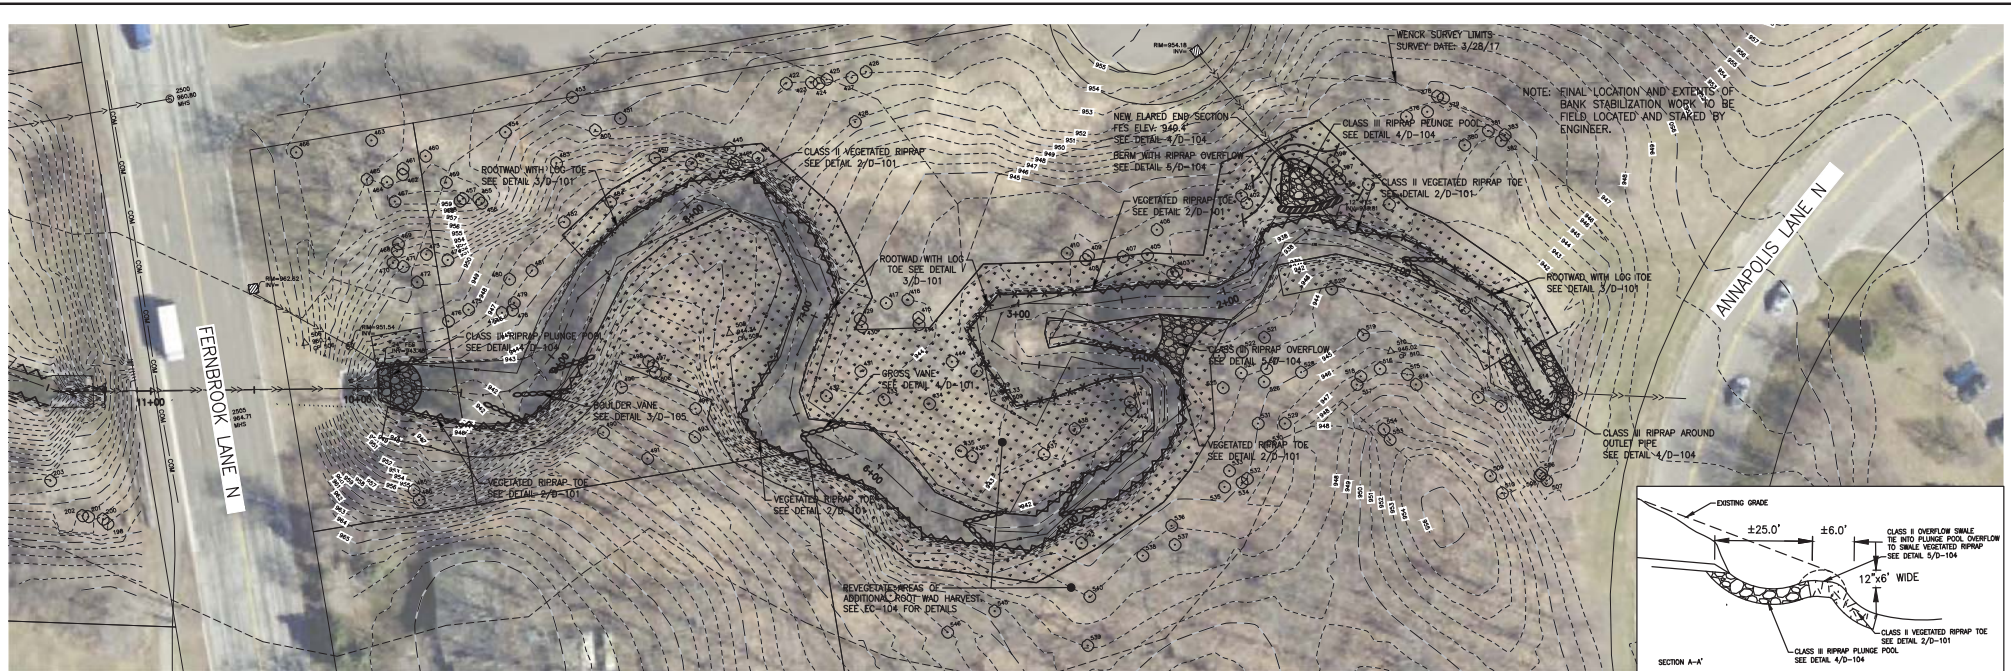PLYMOUTH CREEK CENTERLINE STA 9+00 TO 0+00

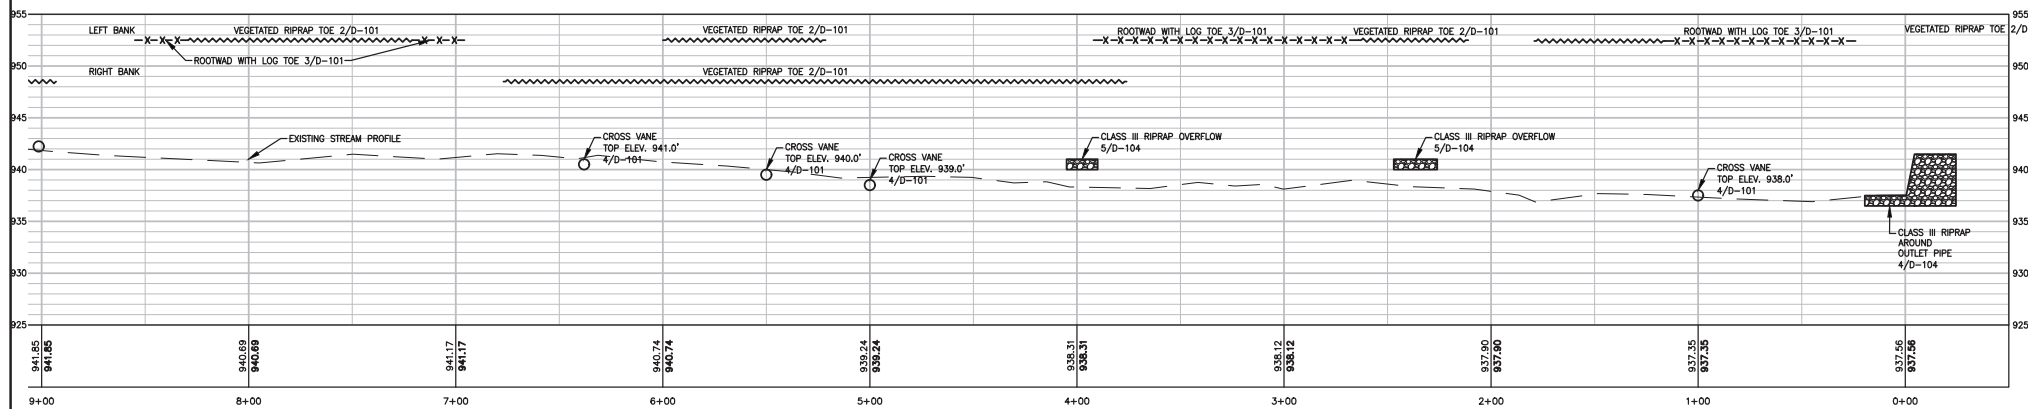

**LEGEND**

	DECIDUOUS TREE		WATER EDGE
	ACCESS ROUTE BOUNDARY		RETAINING WALL
	EXISTING FENCE		PROPOSED CHANNEL CENTERLINE
	PROPERTY LINE		PROJECT AREA LIMITS
	ROOTWAD WITH STONE TOE		ROOTWAD WITH LOG TOE
	BARE ROOT SHRUB PLANTING		VEGETATED RIPRAP TOE
	SHRUB PLANTING WITH BANK ACCESS		



REV	REVISION DESCRIPTION	DWN	APP	REV DATE
1	90% DESIGN	SUB	EAM	06/30/17
0	60% DESIGN	SUB	EAM	04/20/17

NOT FOR CONSTRUCTION

PRIME CONSULTANT

Responsive partner. Exceptional outcomes.

PROJECT TITLE

PLYMOUTH CREEK CHANNEL RECONSTRUCTION

CITY OF PLYMOUTH

3400 PLYMOUTH BOULEVARD  
PLYMOUTH, MN 55447

SHEET TITLE

STABILIZATION PLAN AND PROFILE 9+00 TO 0+00

DWN BY	CHK'D	APP'D	DWG DATE
SUB	LNJ	EAM	MAR 2017
PROJECT NO.	SHEET NO.	SCALE	AS SHOWN
1756-10	C-106		
			REV NO. 1



# HOLE 1: STREAM CROSSING



GRANITE STEPPERS  
60" LONG x 18" WIDE x 7" THICK

HOLE ONE CURRENTLY HAS BANK EROSION WHERE THE FAIRWAY MEETS PLYMOUTH CREEK. THE METHODS PROPOSED TO FIX THE PROBLEM ARE BY INTRODUCING A NEW LOW-FLOW CROSSING POINT WITH BANK STEPS LEADING TO STEPPERS WITHIN THE CREEK BED. INCREASING THE AMOUNT OF VEGETATION THROUGH SHRUB PLANTINGS AND NATIVE GRASSES. THE PUTTING GREEN FOR HOLE FIVE IS LOCATED CLOSE AND TO MITIGATE THE SOIL EROSION THE PROPOSED SOLUTION INCLUDES INCREASING THE HEIGHT OF THE EXISTING BOULDER WALL AND FLATTENING OUT THE "GREEN" AREA. IN ADDITION, ADDING WOOD CHIPS IN THE HIGH TRAFFIC 30 RADIUS OF THE PIN WILL REDUCE THE AMOUNT OF MUD AND IMPROVE PLAY CONDITIONS.

REV	REVISION DESCRIPTION	DWN	APP	REV DATE
1	90% DESIGN	SUB	EAM	06/30/17
0	60% DESIGN	SUB	EAM	04/20/17

SEAL

NOT FOR  
CONSTRUCTION

PRIME CONSULTANT



PROJECT TITLE

PLYMOUTH CREEK  
CHANNEL RECONSTRUCTION

CITY OF PLYMOUTH

3400 PLYMOUTH BOULEVARD  
PLYMOUTH, MN 55447

SHEET TITLE

REFERENCE PICTURES

DWN BY	CHK'D	APP'D	DWG DATE	MAR 2017
SUB	LNJ	EAM	SCALE	AS SHOWN
PROJECT NO.	SHEET NO.		REV NO.	
1756-10	C-601		1	

HOLE 8 LOOKING ACROSS TO TEE BOX OF HOLE 12: STREAM ACCESS + STABILIZATION



STONE STEPS TO CREEKS EDGE



SHRUB PLANTINGS



ON HOLE 8 HAS IS A HIGH POTENTIAL FOR DISC'S TO ENTER THE CREEK. THE EXISTING BANKS ARE IN NEED OF EROSION MITIGATION VEGETATION AND ARMORING. IN ORDER TO ACCOMPLISH BOTH DESIRED OUTCOMES A COMBINATION OF SHRUB PLANTINGS TO STABILIZES THE BANK WITH ACCESS STEPS LEADING TO THE CREEK EDGE FOR FISHING DISC'S OUT. THE OUTSIDE BEND WILL BE ARMORED WITH VEGETATED RIPRAP TO COMBAT FLOW VELOCITY AND PRESERVE THE VISUAL AESTHETIC WITH TALL GRASSES GROWING OVER THE ARMORING.

EXISTING SWALES



RIPRAP SWALE



MULTIPLE EXISTING DRAINAGE SWALES OCCUR WITHIN THE DISC GOLF COURSE. THE ADDITION OF RIPRAP TO STABILIZE THE SOILS WILL MITIGATE SOIL MIGRATION INTO THE CREEK. PLAYABILITY OF THE COURSE WILL NOT BE AFFECTED AND A REDUCTION OF OVERALL MUD WILL BE ACHIEVED.

REV	REVISION DESCRIPTION	DWN	APP	REV DATE
1	90% DESIGN	SJB	EAM	06/30/17
0	60% DESIGN	SJB	EAM	04/20/17

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Responsive partner. Exceptional outcomes.

PROJECT TITLE

PLYMOUTH CREEK  
CHANNEL RECONSTRUCTION

CITY OF PLYMOUTH


3400 PLYMOUTH BOULEVARD  
PLYMOUTH, MN 55447

SHEET TITLE

REFERENCE PICTURES

DWN BY	CHK'D	APP'D	DWG DATE	MAR 2017
SJB	LNJ	EAM	SCALE	AS SHOWN
PROJECT NO.	SHEET NO.		REV NO.	
1756-10	C-602		1	

### HOLE 8: MUDDY PATH OPTIONS

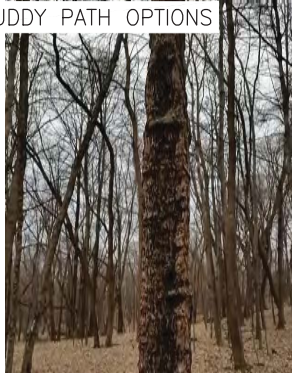

EXISTING TREES WITHIN THE FLIGHT PATH ARE SCARRED BY DISCS REPEATEDLY HITTING THE SOFT TISSUE OF YOUNG TREES. TO PROTECT THE TREES DISC STOP POLES WOULD BE PLACED BETWEEN THE TREE AND THE DIRECTION OF FLYING DISCS. WITH STAGGERED ROWS OF POLES DEFLECTION WILL SERVE TO PROTECT TREES.



SHRUB PLANTINGS



DISC STOP POLES



BOARDWALK TO MATCH EXISTING

FOR AREAS OF HEAVY FOOT TRAFFIC IN SUNNY LOCATIONS THE USE OF GRASSPAVE2 WOULD ALLOW FOR REDUCED COMPACTION AND TRAMPLING OF TURF GRASS COVER. THE SOILS IN THESE LOCATIONS WOULD THUS BE STABILIZED WHILE ALLOWING FOR CONSISTENT GOLFER TRAFFIC. IN AREAS OF HEAVILY SHADE DUE TO TREE CANOPY THE USE OF ADDITIONAL BOARDWALKS WILL SERVE TO FOCUS TRAFFIC MOVEMENTS AROUND TREE ROOTS AND BARE SOILS.



GRASS PAVE2



STEEP SLOPES CAN BE RECTIFIED THROUGH THE USE OF BOARDWALKS WHICH ALSO MINIMIZES THE FOOT TRAFFIC TRAMPLING ANY VEGETATION. THE ADDITION OF DISC STOP POLES WILL PROTECT EXISTING/NEWLY PLANTED TREES AND ADD A NEW ELEMENT OF DIFFICULTY FOR PLAYERS TO SHOOT AROUND.



REV	REVISION DESCRIPTION	DWN	APP	REV DATE
1	90% DESIGN	SUB	EAM	06/30/17
0	60% DESIGN	SUB	EAM	04/20/17

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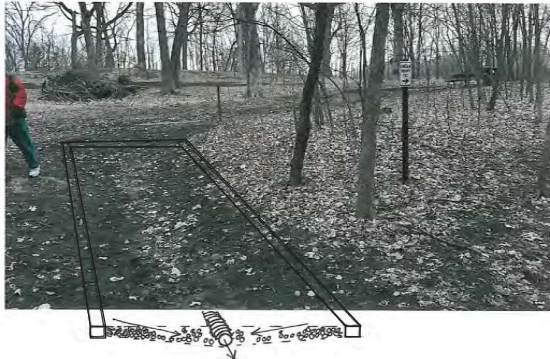


Responsive partner. Exceptional outcomes.

PROJECT TITLE	
PLYMOUTH CREEK CHANNEL RECONSTRUCTION	
CITY OF PLYMOUTH	
3400 PLYMOUTH BOULEVARD PLYMOUTH, MN 55447	

SHEET TITLE			
REFERENCE PICTURES			
DWN BY	CHK'D	APP'D	DWG DATE
SUB	LNJ	EAM	MAR 2017
PROJECT NO.		SHEET NO.	
1756-10		C-603	
			REV NO.
			1

### HOLE 11: MUDDY TEE BOX OPTIONS



FOR AREAS OF HEAVY FOOT TRAFFIC IN AND AROUND SHADY TEE BOXES THE PATHWAYS CAN BE BOXED IN USING PRESSURE TREATED TIMBERS AND THE BOXES FILLED WITH EITHER WOODCHIPS OR GRAVEL. THIS WILL SERVE TO REDUCE THE AMOUNT OF MUD AND KEEP THE SOIL MIGRATION DOWN.



REV	REVISION DESCRIPTION	DWN	APP	REV DATE
1	90% DESIGN	SUB	EAM	06/30/17
0	60% DESIGN	SUB	EAM	04/20/17

SEAL

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CONSTRUCTION

PRIME CONSULTANT



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PROJECT TITLE  
**PLYMOUTH CREEK  
CHANNEL RECONSTRUCTION**

CITY OF PLYMOUTH  
3400 PLYMOUTH BOULEVARD  
PLYMOUTH, MN 55447

SHEET TITLE			
<b>REFERENCE PICTURES</b>			
DWN BY SJB	CHK'D LNJ	APP'D EAM	DWG DATE MAR 2017
PROJECT NO. 1756-10	SHEET NO. C-604	SCALE AS SHOWN	
			REV NO. 1

## OXE-BOW: POLINATOR HABITAT + FOOD



THE RUSTY PATCHED BUMBLEBEE BECAME THE FIRST BEE SPECIES EVER LISTED UNDER THE ENDANGERED SPECIES ACT IN MARCH OF THIS YEAR; HOWEVER, POLLINATORS OF ALL KINDS (BEES, MOTHS, AND BUTTERFLIES) ARE CURRENTLY IN A DECLINING STATE ACROSS THE U.S. FOR THE ISLAND OFF THE EDGE OF THE COURSE BEHIND THE OXE-BOW A DEDICATED POLLINATOR HABITAT AND NECTAR SOURCE IS PLANNED. A COMBINATION OF SEEDING NATIVE GRASSES AND FORBS ARE PROPOSED, AS WELL AS, POTTED FORBS TO INCREASE THE DENSITY. IN ORDER TO ACHIEVE THE NECESSARY SUNLIGHT FOR THESE SPECIES THE CURRENT TREES WILL BE REMOVED.



IN ADDITION TO THE POLLINATOR SPECIFIC ISLAND, NATIVE SEED MIXES AND FLOWERING SHRUB SPECIES WILL BE USED TO STABILIZE THE BANKS OF THE CREEK. THE DENSITY OF FLOWERS WILL NOT BE AS INTENSE BUT THEY WILL SERVE AS A CONNECTIVE PATHWAY ALONG THE CREEK TO THE GREATER LANDSCAPE WITHIN PLYMOUTH. LIKE THE POLLINATOR ISLAND, TREES ALONG THE CORRIDOR WILL NEED TO BE REMOVED TO ALLOW NEEDED SUNLIGHT FOR THE NEW COVER TYPES. REMOVALS WILL BE LIMITED TO ONLY WHAT IS NECESSARY AS TO NOT CHANGE THE CHARACTER OF THE PARK AND THE DISC GOLF COURSE.



						SEAL
1	90% DESIGN	SUB	EAM	06/30/17		
0	60% DESIGN	SUB	EAM	04/20/17		
REV	REVISION DESCRIPTION	DWGN	APP	REV DATE		

NOT FOR  
CONSTRUCTION

PRIME CONSULTANT



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PROJECT TITLE	PLYMOUTH CREEK CHANNEL RECONSTRUCTION
CITY OF PLYMOUTH	
3400 PLYMOUTH BOULEVARD PLYMOUTH, MN 55447	

SHEET TITLE					
REFERENCE PICTURES					
DWGN BY	CHK'D	APP'D	DWG DATE	MAR 2017	
SUB	LNJ	EAM	SCALE	AS SHOWN	
PROJECT NO.	SHEET NO.			SHEET NO.	REV NO.
1756-10	C-605				1

**Construction Dates:** Fall 2017 - Spring 2018

**Party Responsible for Long Term Operation and Maintenance of the Site - OWNER**

City of Plymouth  
3400 Plymouth Boulevard  
Plymouth, MN 55447-1482

Derek Asche, Water Resources Manager  
763-509-5526  
engineering@plymouthmn.gov

**Party Responsible for Implementation of the SWPPP - CONTRACTOR**

Contractor	
Contact Name	
Phone	
Email	

**Surface Area Tabulation**

Total Disturbed Area	1.5 acres
Existing Impervious Area	0.1 acres
Proposed Impervious Area	0.1 acres
Net Impervious Area Increase	<0.1 acres

**Project Description**

The project consists of riparian buffer restoration, streambank stabilization, installation of boardwalk, path improvements, and improvements to several existing disc golf holes and tee boxes.

**Temporary Sediment Basin**

Because the total disturbed area for this project is less than 5 acres, there are no additional temporary sedimentation basin requirements.

**EROSION AND SEDIMENT CONTROL PRACTICES**

All exposed soil areas must have temporary erosion protection (erosion control blanket, seed) as soon as possible or within 7 days after the construction activity in that portion of the site has temporarily or permanently ceased.

CONTRACTOR shall implement appropriate construction phasing, vegetative buffer strips, horizontal slope grading, and other construction practices that minimize erosion when practical. The normal wetted perimeter of any temporary or permanent drainage ditch that drains water from a construction site, or diverts water around a site, must be stabilized within 200 lineal feet from the property edge, or from the point of discharge to any surface water. Stabilization must be completed within 24 hours of connecting to a surface water. Pipe outlets must be provided with temporary or permanent energy dissipation within 24 hours of connection to a surface water.

The following measures will be taken as sediment control practices in order to minimize sediments from entering surface waters:  
The following measures will be taken as sediment control practices in order to minimize sediments from entering surface waters:

1. Installation of floating silt curtain within the creek channel at the downgradient extents of construction activity prior to site disturbance. Floating silt curtain shall be installed in two locations upgradient of the culverts under Fernbrook Lane and Annapolis Lane as shown on Sheets EC-102 and EC-103. Install silt curtain as shown on Sheet D-104.
2. Installation of perimeter silt fence in the locations shown on Sheets EC-102 through EC-104 prior to site disturbance. Perimeter silt fence shall be installed as shown on Sheet D-104.
3. Installation of inlet protection in the locations shown on Sheets EC-102 through EC-104 prior to site disturbance. Inlet protection shall be installed as shown on Sheet D-104.
4. Installation of rock construction entrances in the locations shown on Sheet C201. Rock construction entrances shall be constructed as shown on Sheet C803 to prevent tracking of sediment offsite. Street sweeping of tracked sediment shall be performed as required.

**Pollution Prevention Measures**

**Solid Waste**

Solid waste, including but not limited to, collected asphalt and concrete millings, floating debris, paper, plastic, fabric, construction and demolition debris and other waste must be disposed of properly and must comply with MPCA disposal requirements.

**Hazardous Materials**

Hazardous materials, including but not limited to oil, gasoline, paint and any hazardous substance must be properly stored including secondary containments, to prevent spills, leaks or other discharge. Restricted access to storage areas must be provided to prevent vandalism. Storage and disposal of hazardous waste must be in compliance with MCPA regulations.

**Washing of Construction Vehicles**

External washing of trucks and other construction vehicles must be limited to a defined area of the site. Runoff must be contained and waste properly disposed of. No engine degreasing is allowed on site.

**Concrete Washout Area**

The contractor shall provide effective containment for all liquid and solid wastes generated by washout operations to prevent runoff to surface waters. Liquid and solid wastes must be disposed of properly in compliance with MPCA rules.

**Amendments**

Amend the SWPPP as necessary to address any changes in design, construction, operation, maintenance, weather or seasonal conditions that have a significant effect on discharge of pollutants to surface or underground waters; or to address concerns identified during inspections or investigations by OWNER or local government entities.

**Record Retention**


The SWPPP, all changes to it, and inspection and maintenance records must be kept on-site during construction. The OWNER must retain a copy of the SWPPP along with the following records for three (3) years after submittal of the Notice of Termination.

1. Any other permits required for the project;
2. Records of all inspection and maintenance conducted during construction;
3. All permanent operations and maintenance agreements that have been implemented, including all right of way, contract, covenants and other binding requirements regarding perpetual maintenance;
4. All required calculations for design of the temporary and permanent stormwater management systems.

**Inspections**

The inspection log will be completed by the CONTRACTOR for the construction site. Inspections at the site will be completed as follows:  
Once every seven (7) days during active construction and, Within 24 hours after a rainfall event greater than 0.5 inches in 24 hours.

The individual performing inspections must be trained as required by part IV.E of the Permit. CONTRACTOR to provide OWNER with proof of training. Inspections must include stabilized areas, erosion prevention and sediment control BMPs, and infiltration areas. Corrective actions must be identified and date of correction must be noted as identified in Section IV.E. of the Permit.

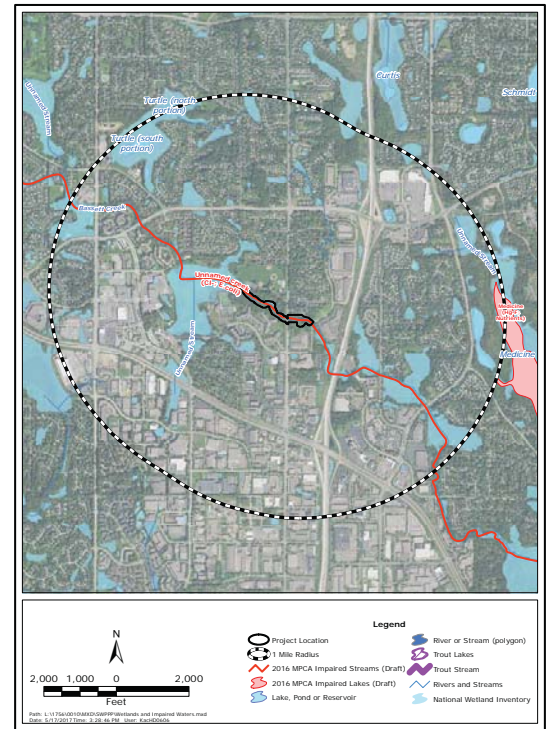

**IMPAIRED WATERS, SPECIAL WATERS, AND WETLANDS**

This Project is not located within 1 mile of a special water.


This Project is located within 1 mile of an impaired water (see figure above):

Plymouth Creek impaired for Ch. E. coli  
Because of the proximity of the project to an impaired water during construction, all exposed soil areas must be stabilized as soon as possible to limit soil erosion but in no case later than 7 days after the construction activity in that portion of the site has temporarily or permanently ceased.

This Project will impact wetlands. A wetland delineation has been performed and wetland permits have been obtained.

**EROSION CONTROL ESTIMATED QUANTITIES**

Material	Quantity
MnDOT Seed Mix 34-262	14.5 lb/acre x 0.4 acres = 6 LBS
Erosion Control Blanket	1,650 SY
Inlet Protection	5 EA
Flotation Silt Curtain	50 LF
Construction Entrance	4 EA
Bioret	200 LF
Silt Fence	400 LF

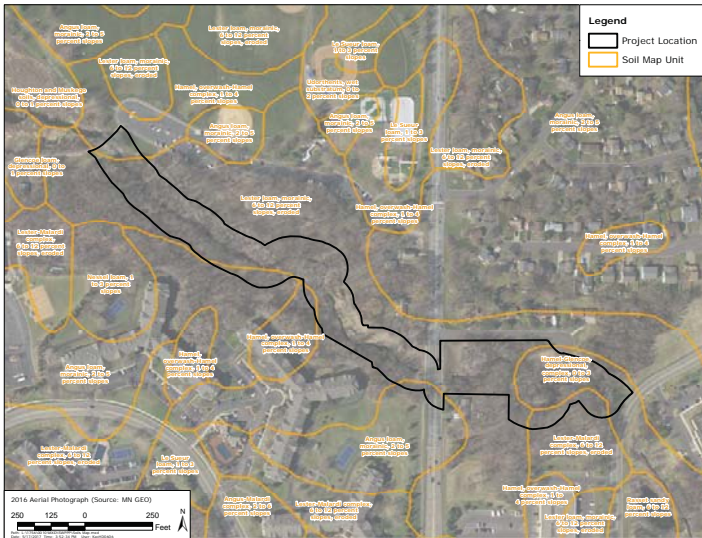

**Dewatering**

Turbid or sediment-laden water must be treated with the appropriate BMPs, such that discharge does not adversely affect the receiving water. Ensure that discharge points are adequately protected from erosion and scour. CONTRACTOR responsible to develop and submit dewatering plan to engineer, secure any required permits, and comply with permits.

**Final Stabilization**

All areas disturbed by construction will receive seed according to the plans and specifications and within the specified vegetative time schedule.

Final stabilization will occur when the site has a uniform vegetative cover with a density of 70% over the entire disturbed area. All temporary synthetic erosion prevention and sediment control BMPs (such as silt fence) must be removed as part of the site final stabilization. All sediment must be cleaned out of conveyances and temporary sedimentation basins if applicable.

Notice of Termination (NOT) must be submitted within 30 days of final stabilization. Before Termination, revegetation establishment and coverage must meet the permit requirements.

**UNIVERSITY OF MINNESOTA**

**Louis H Sigtermans**  
Minneapolis, MN

Design of Construction SWPPP  
(May 31, 2020)

**CERTIFICATION**

In accordance with Part III.A.2 of the General Permit Authorization to Discharge Stormwater Associated with Construction Activity under the NPDES, the preparer of this document was trained under the University of Minnesota Erosion and Sediment Control Certification Program. Mr. Louis Sigtermans' certification in Design of SWPPP is valid through May 31, 2020.

REV	REVISION DESCRIPTION	DWN	APP	REV DATE
0	60% DESIGN			04/20/17

SEAL

NOT FOR  
CONSTRUCTION

PRIME CONSULTANT

Responsive partner. Exceptional outcomes.

PROJECT TITLE	PLYMOUTH CREEK CHANNEL RECONSTRUCTION
CITY OF PLYMOUTH	
3400 PLYMOUTH BOULEVARD PLYMOUTH, MN 55447	

SHEET TITLE	SWPPP			
DWN BY	CHK'D	APP'D	DWG DATE	MAR 2017
SUB	LNJ	EAM	SCALE	AS SHOWN
PROJECT NO.	SHEET NO.	REV NO.		
1756-10	EC-101	0		



**LEGEND**

- |  |  |  |                             |
|--|--|--|-----------------------------|
|  | DECIDUOUS TREE                                       |  | WATER EDGE                  |
|  | ACCESS ROUTE BOUNDARY                                |  | RETAINING WALL              |
|  | EXISTING FENCE                                       |  | PROPOSED CHANNEL CENTERLINE |
|  | PROPERTY LINE  |  | PROJECT AREA LIMITS         |
|  | STRAW MULCH W/ DISK ANCHORING AND MN SEED MIX 34-262 |  | FLOTATION SILT CURTAIN      |
|  | EROSION CONTROL BLANKET AND MN SEED MIX 34-262       |  | INLET PROTECTION            |
|  |  |  | BIOROLL                     |
|  |  |  | SILT FENCE                  |



REV	REVISION DESCRIPTION	DWN	APP	REV DATE
1	90% DESIGN	SUB	EAM	06/30/17
0	60% DESIGN	SUB	EAM	04/20/17

SEAL

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PROJECT TITLE

PLYMOUTH CREEK CHANNEL RECONSTRUCTION

CITY OF PLYMOUTH  
3400 PLYMOUTH BOULEVARD  
PLYMOUTH, MN 55447

SHEET TITLE

EROSION AND SEDIMENT CONTROL PLAN  
27+18 TO 18+00


DWN BY	CHK'D	APP'D	DWG DATE	MAR 2017
SUB	LNJ	EAM	SCALE	AS SHOWN
PROJECT NO.	SHEET NO.	SHEET NO.	REV NO.	
1756-10	EC-102		1	



**LEGEND**

	DECIDUOUS TREE		WATER EDGE
	ACCESS ROUTE BOUNDARY		RETAINING WALL
	EXISTING FENCE		PROPOSED CHANNEL CENTERLINE
	PROPERTY LINE		PROJECT AREA LIMITS
	STRAW MULCH W/ DISK ANCHORING AND MN SEED MIX 34-282		FLOTATION SILT CURTAIN
	EROSION CONTROL BLANKET AND MN SEED MIX 34-282		INLET PROTECTION
			BIOROLL
			SILT FENCE

	WATER EDGE
	RETAINING WALL
	PROPOSED CHANNEL CENTERLINE
	PROJECT AREA LIMITS
	FLOTATION SILT CURTAIN
	INLET PROTECTION
	BIOROLL
	SILT FENCE

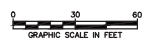

REV	REVISION DESCRIPTION	DWN	APP	REV DATE
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PROJECT TITLE  
**PLYMOUTH CREEK CHANNEL RECONSTRUCTION**

CITY OF PLYMOUTH  
 3400 PLYMOUTH BOULEVARD  
 PLYMOUTH, MN 55447

SHEET TITLE			
<b>EROSION AND SEDIMENT CONTROL PLAN</b>			
<b>18+00 TO 9+00</b>			
DWN BY	CHK'D	APP'D	DWG DATE
SUB	LNJ	EAM	MAR 2017
PROJECT NO.	SHEET NO.	SCALE	AS SHOWN
1756-10	EC-103		
			REV NO.
			1





**LEGEND**

	DECIDUOUS TREE		WATER EDGE
	ACCESS ROUTE BOUNDARY		RETAINING WALL
	EXISTING FENCE		PROPOSED CHANNEL CENTERLINE
	PROPERTY LINE		PROJECT AREA LIMITS
	STRAW MULCH W/ DISK ANCHORING AND MIN SEED MIX 34-262		FLOTATION SILT CURTAIN
	EROSION CONTROL BLANKET AND MIN. SEED MIX 34-262		INLET PROTECTION
			BIOROLL
			SILT FENCE

	WATER EDGE
	RETAINING WALL
	PROPOSED CHANNEL CENTERLINE
	PROJECT AREA LIMITS
	FLOTATION SILT CURTAIN
	INLET PROTECTION
	BIOROLL
	SILT FENCE



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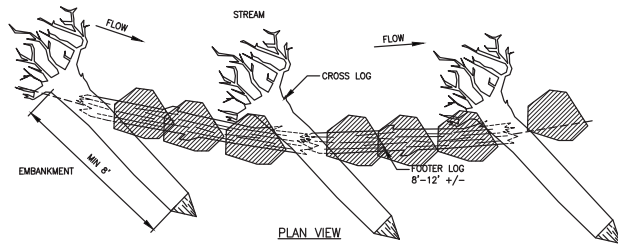
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PROJECT TITLE  
**PLYMOUTH CREEK CHANNEL RECONSTRUCTION**


CITY OF PLYMOUTH  
 3400 PLYMOUTH BOULEVARD  
 PLYMOUTH, MN 55447

SHEET TITLE  
**EROSION AND SEDIMENT CONTROL PLAN**  
**9+00 TO 0+00**


DWN BY	CHK'D	APP'D	DWG DATE	MAR 2017
SUB	LNJ	EAM	SCALE	AS SHOWN
PROJECT NO.	SHEET NO.	EC-104		REV NO.
1756-10				1



PLAN VIEW

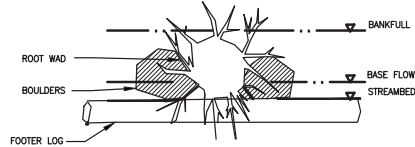


ELEVATION VIEW

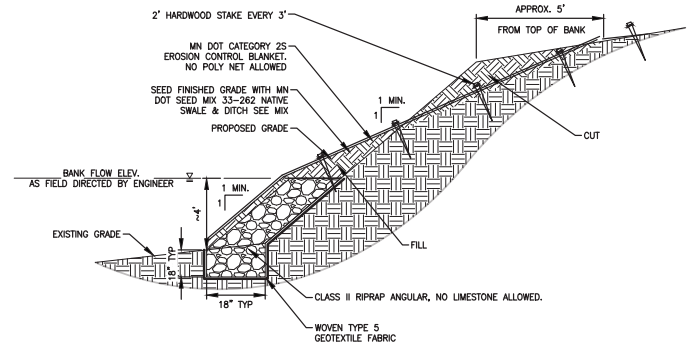

CLASS II VEGETATED RIPRAP TOE DETAIL (2) NOT TO SCALE (D-101)


**GENERAL NOTES:**

- ENGINEER TO FIELD VERIFY ROOT WAD PLACEMENT.
- SEE PLANS FOR SPECIFIED BIOTECHNICAL TREATMENTS.
- FOOTER LOG MINIMUM OF 12" DIAMETER BY 8' LONG.
- A MINIMUM OF TWO CROSS LOGS PER FOOTER LOG IS REQUIRED TO ANCHOR FOOTER LOG.
- BOULDERS SHALL BE 24" TO 36", 350 LBS. TO 450 LBS. UN-CUT, UN-DRESSED FIELDSTONE BOULDERS TO BE FIELD LOCATED. COORDINATE WITH ENGINEER.
- ROOTWAD SHALL BE DRIVEN OR EXCAVATED INTO BANK.

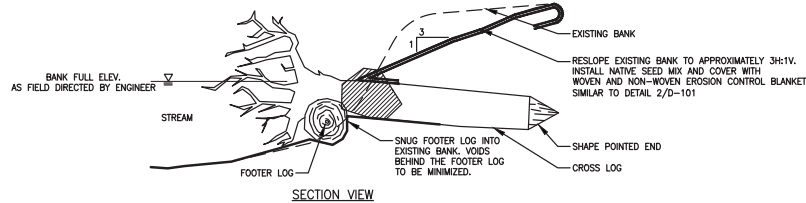


SECTION VIEW

ROOTWAD WITH BOULDER TOE (1) NOT TO SCALE (D-101)

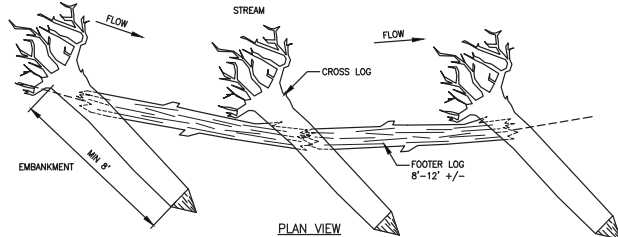

PLAN VIEW

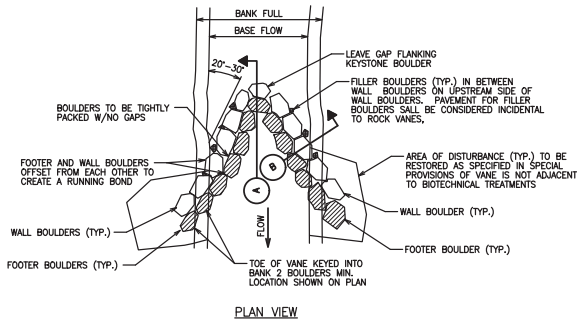


PLAN VIEW

**LEGEND**

- SUBMERGED OR FOOTER 24" TO 30" FIELDSTONE BOULDER MEETING MNDOT 3601.2A. AT LEAST 20% OF THE BOULDERS SHALL HAVE A DIAMETER OF 24" OR LARGER.
- PROTRUDING OR WALL 30" TO 36" BOULDERS MEETING MNDOT 3601.2A. AT LEAST 20% OF THE BOULDERS SHALL HAVE A DIAMETER OF 30" OR LARGER.
- FILLER BOULDER 6" TO 12" DIA.

**NOTE:**


- FIELD STONE BOULDERS SHALL HAVE NO CUT, BLAST OR SHEAR MARKS.
- ENOUGH WALL BOULDERS TO BE FLAT TOPPED AND SET TO CREATE A DRY CROSSING/WALKWAY ACROSS THE CREEK.
- FINAL PLACEMENT OF ROCK VANE AND BOULDERS TO BE FIELD VERIFIED BY ENGINEER.
- ALL VANES EXTEND UPSTREAM INTO FLOW OF CREEK.
- CLASS V RIPRAP ACCEPTABLE ROCK ALTERNATIVE

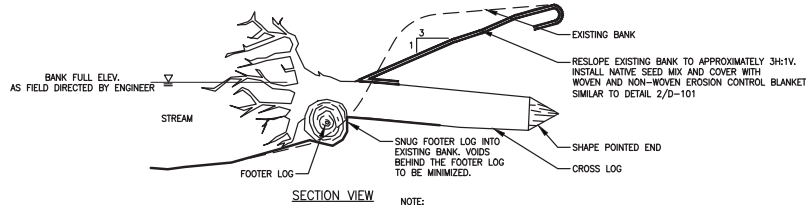


SECTION VIEW

- NOTE:**
- A MINIMUM OF TWO CROSS LOGS PER FOOTER LOG IS REQUIRED TO ANCHOR FOOTER LOG.
  - MINIMUM LOG DIAMETER IS 12" +/-

ROOTWAD WITH LOG TOE (3) NOT TO SCALE (D-101)

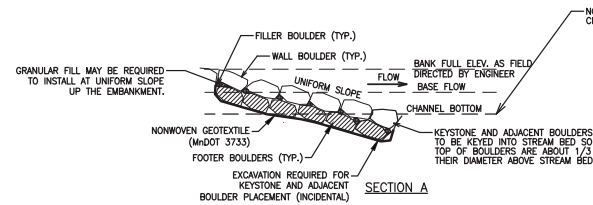

SECTION A

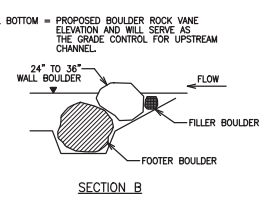

SECTION B

CROSS VANE DETAIL (4) NOT TO SCALE (D-101)

REV	REVISION DESCRIPTION	DWN	APP	REV DATE
1	90% DESIGN	SUB	EAM	06/30/17
0	60% DESIGN	SUB	EAM	04/20/17


NOT FOR CONSTRUCTION

PRIME CONSULTANT  
  
 Responsive partner. Exceptional outcomes.


PROJECT TITLE  
 PLYMOUTH CREEK CHANNEL RECONSTRUCTION  
 CITY OF PLYMOUTH  
 3400 PLYMOUTH BOULEVARD PLYMOUTH, MN 55447

SHEET TITLE  
**DETAILS**


DWN BY	CHK'D	APP'D	DWG DATE	MAR 2017
SUB	LNJ	EAM	SCALE	AS SHOWN
PROJECT NO.	SHEET NO.		REV NO.	
1756-10	D-101		1	

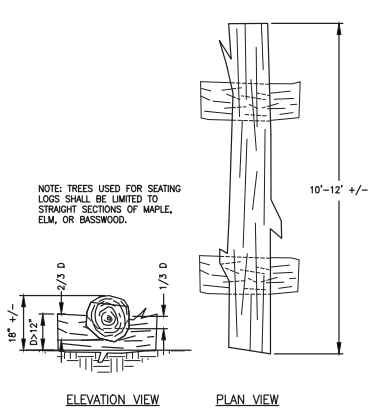


**SEATING LOGS/REVEGETATION BOUNDARY**  
NOT TO SCALE (1) D-102

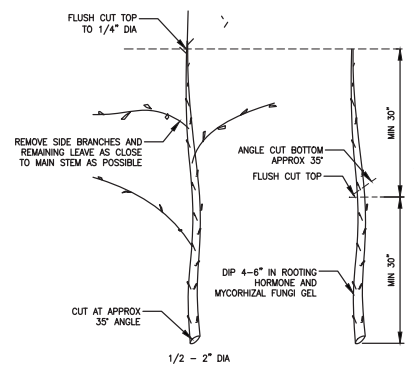


**LIVE STAKE HARVEST AND INSTALLATION**  
NOT TO SCALE (2) D-102

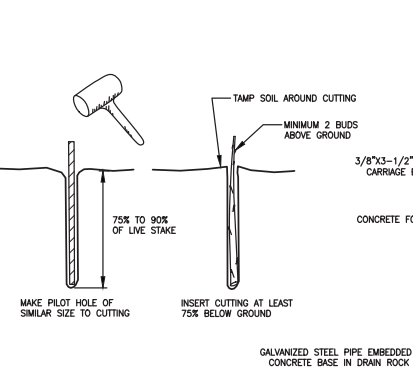


**DISC STOP POLES**  
NOT TO SCALE (3) D-102

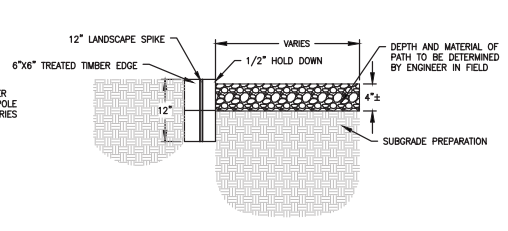


**TIMBER EDGE PATH**  
NOT TO SCALE (4) D-102

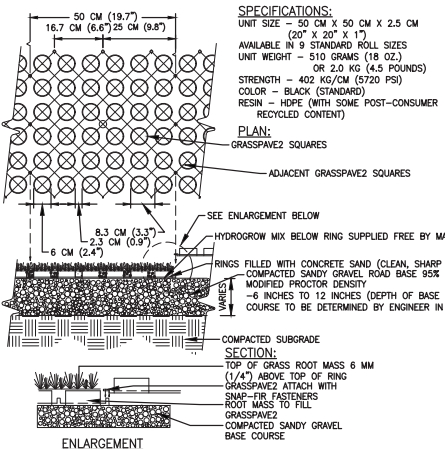


**GRASSPAVE2 DETAIL**  
NOT TO SCALE (5) D-102

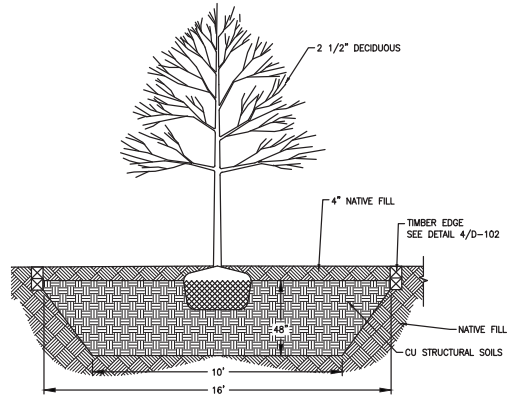

**TREE WITH STRUCTURAL SOIL BASE**  
NOT TO SCALE (6) D-102

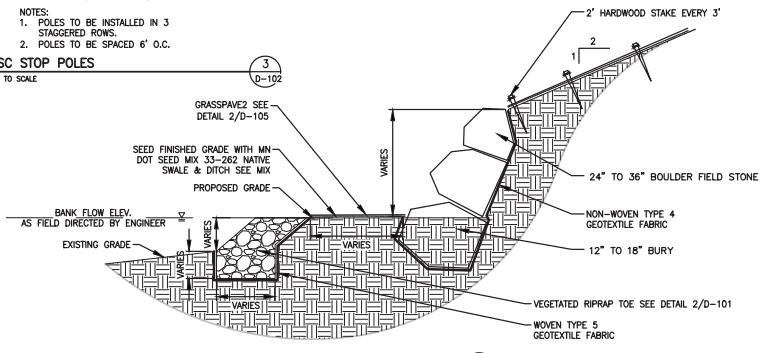

**TWO STAGE CHANNEL CLASS II RIPRAP TOE & BOULDER DETAIL**  
NOT TO SCALE (7) D-102

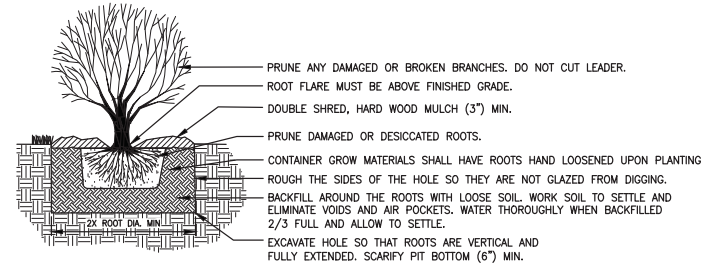

**SHRUB PLANTING**  
NOT TO SCALE (8) D-102


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1	90% DESIGN	SUB	EAM	06/30/17
0	60% DESIGN	SUB	EAM	04/20/17

NOT FOR  
CONSTRUCTION


PRIME CONSULTANT  
  
 Responsive partner. Exceptional outcomes.

PROJECT TITLE  
**PLYMOUTH CREEK  
 CHANNEL RECONSTRUCTION**  
 CITY OF PLYMOUTH  
 3400 PLYMOUTH BOULEVARD  
 PLYMOUTH, MN 55447


SHEET TITLE			
DETAILS			
DWN BY	CHK'D BY	APP'D BY	DWG DATE
SUB	LNJ	EAM	MAR 2017
PROJECT NO.	SHEET NO.	SCALE	AS SHOWN
1756-10	D-102		
REV NO.	1		

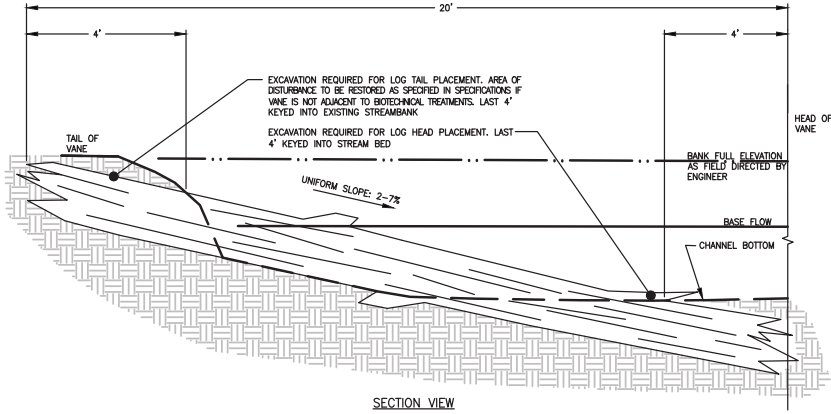


SECTION VIEW

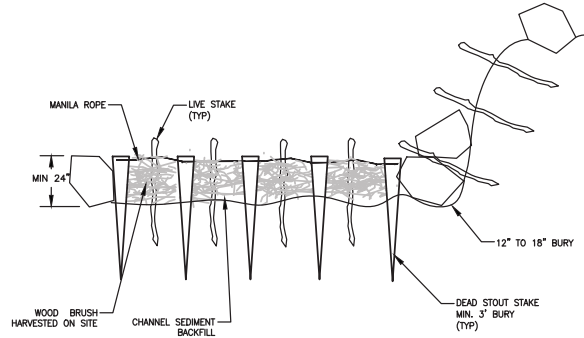

SECTION VIEW A-A

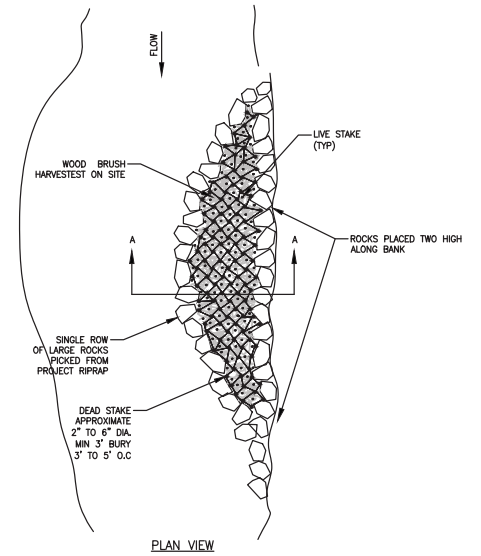


PLAN VIEW

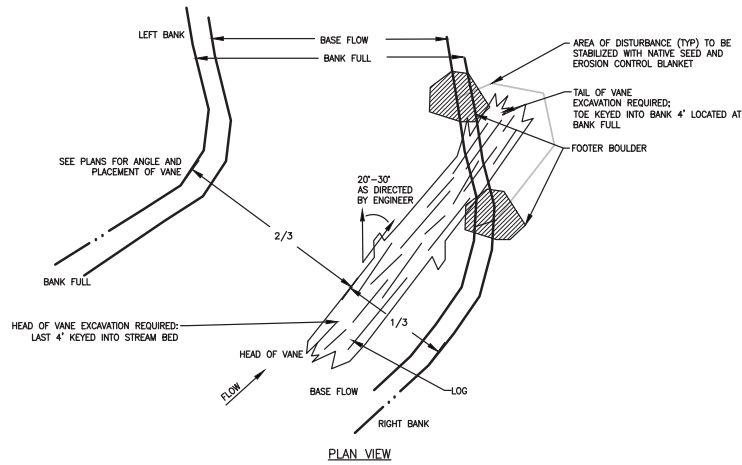

PLAN VIEW

LOG VANE DETAIL (TYPICAL)  
NOT TO SCALE

1  
P-103

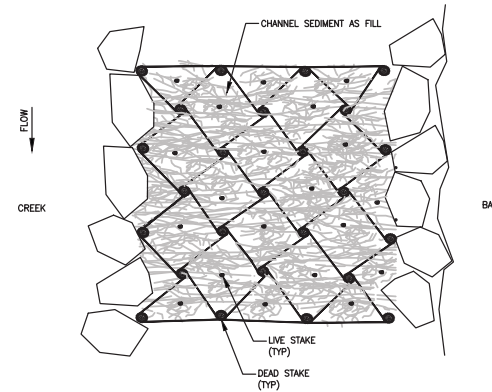

PLAN VIEW

- NOTES:
1. MANILA ROPE - MINIMUM 3/8" NATURAL FIBER TWISTED ROPE WITH 500 LB BREAK STRENGTH.
  2. DEAD STAKES MAY BE HARVESTED ON SITE 3' TO 5' O.C. MIN 3' BURY, APPROXIMATE 2"-6" DIAMETER.
  3. OVERLAY BRANCHES
  4. LIVE STAKES 3' TO 5' O.C., MIN 2' BURY MIN 12" ABOVE MATTRESS.

BRUSH MATTRESS  
NOT TO SCALE

2  
P-103

REV	REVISION DESCRIPTION	DWN	APP	REV DATE
1	90% DESIGN	SUB	EAM	06/30/17
0	60% DESIGN	SUB	EAM	04/20/17

SEAL

NOT FOR CONSTRUCTION

PRIME CONSULTANT



PROJECT TITLE

PLYMOUTH CREEK CHANNEL RECONSTRUCTION



CITY OF PLYMOUTH

3400 PLYMOUTH BOULEVARD  
PLYMOUTH, MN 55447

SHEET TITLE


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DWN BY	CHK'D	APP'D	DWG DATE	MAR 2017
SUB	LNJ	EAM	SCALE	AS SHOWN
PROJECT NO.	SHEET NO.		REV NO.	
1756-10	D-103		1	

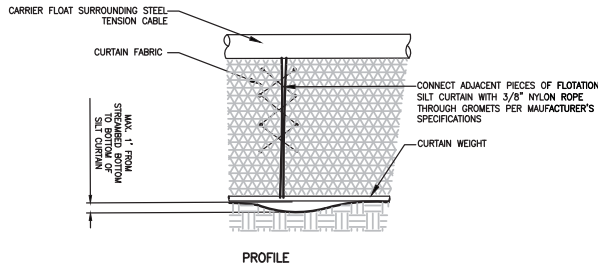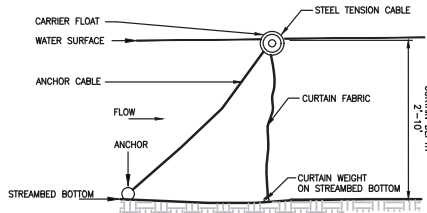


**FLOTATION SILT CURTAIN**  
NOT TO SCALE

- NOTES:**
1. DIG A 6"x6" TRENCH ALONG THE INTENDED FENCE LINE.
  2. DRIVE ALL POSTS INTO THE GROUND AT THE DOWNHILL SIDE OF THE TRENCH.
  3. WIRE FENCING PER HENNEPIN COUNTY CONSERVATION DISTRICT EROSION AND SEDIMENT CONTROL MANUAL. WIRE MESH MUST BE A MINIMUM OF 3" INTO THE GROUND AND NO MORE THAN 36" ABOVE THE ORIGINAL GROUND SURFACE.
  4. LAY OUT SILT FENCE ON THE UPHILL SIDE ALONG THE FENCE LINE, AND BACK FILL.
  5. WOOD POSTS MAY BE SPACED UP TO 4 FEET APART IF WIRE MESH IS NOT USED TO SUPPORT THE FABRIC. IF WIRE MESH IS USED TO SUPPORT THE FABRIC STEEL POSTS MAY BE SPACED UP TO 8 FEET APART.
  6. REMOVE SILT FENCE AFTER TURF IS ESTABLISHED.

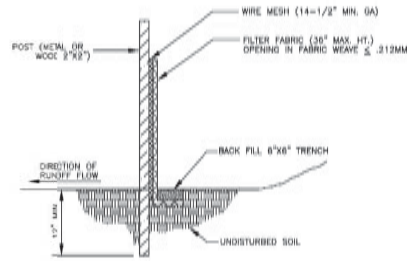


**STANDARD DETAILS  
SILT FENCE DETAIL  
CITY OF PLYMOUTH**

**SILT FENCE**  
NOT TO SCALE

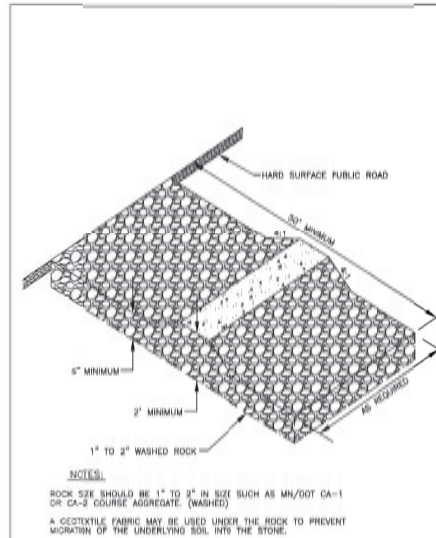


**STANDARD DETAILS  
ROCK ENTRANCE TO CONSTRUCTION SITE  
CITY OF PLYMOUTH**

**ROCK ENTRANCE TO CONSTRUCTION SITE**  
NOT TO SCALE

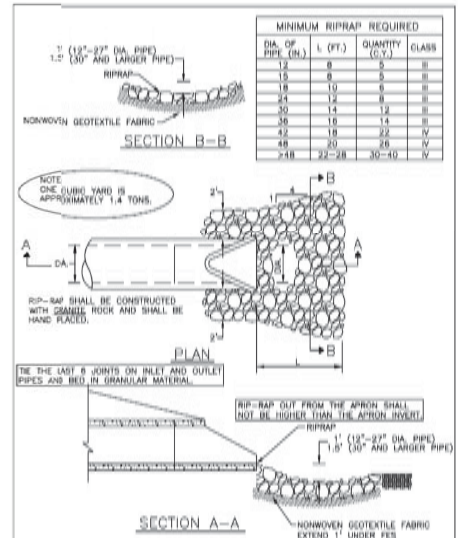


**STANDARD DETAILS  
RIPRAP DETAIL FOR FLARED END SECTIONS  
CITY OF PLYMOUTH**


**RIPRAP AT FLARED END SECTIONS DETAIL**  
NOT TO SCALE

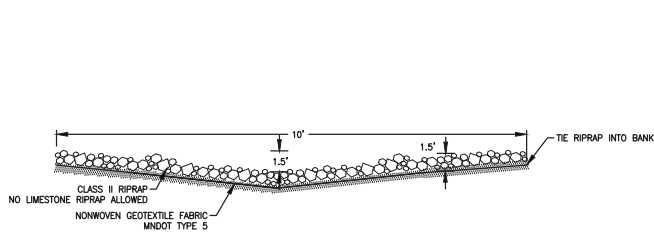


**CLASS II RIPRAP SWALE**  
NOT TO SCALE

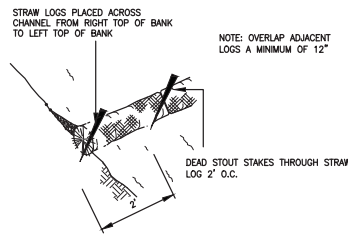

**BIOROLL DETAIL**  
NOT TO SCALE

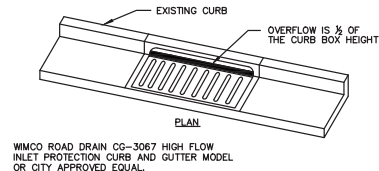

**INLET PROTECTION DETAIL**  
NOT TO SCALE

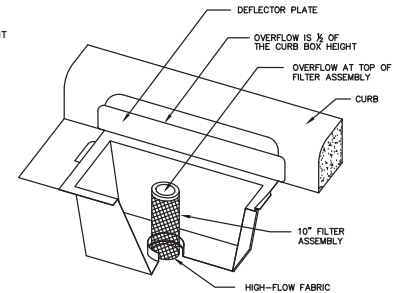

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0	60% DESIGN	SUB	EAM	04/20/17

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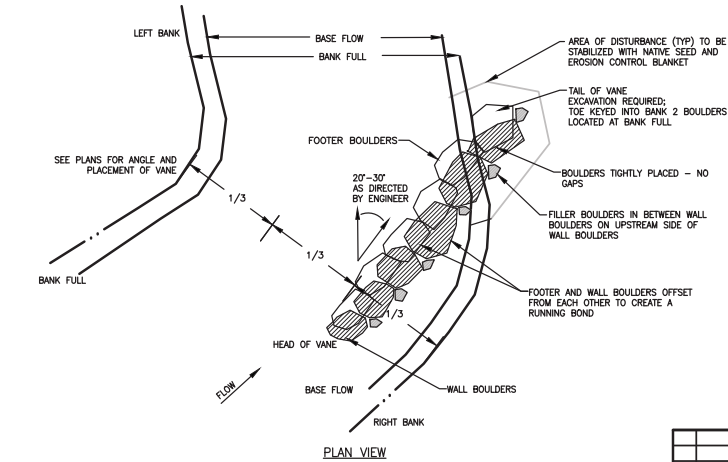
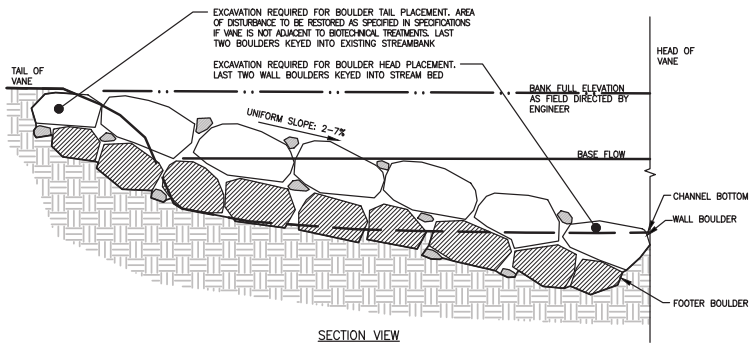
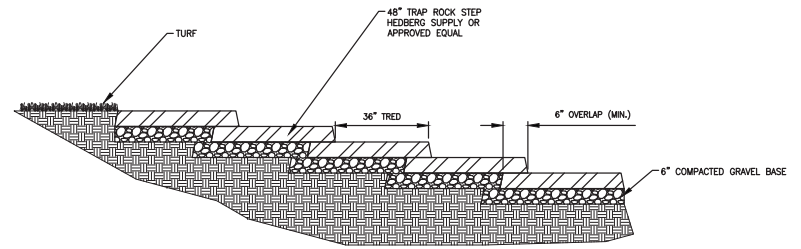
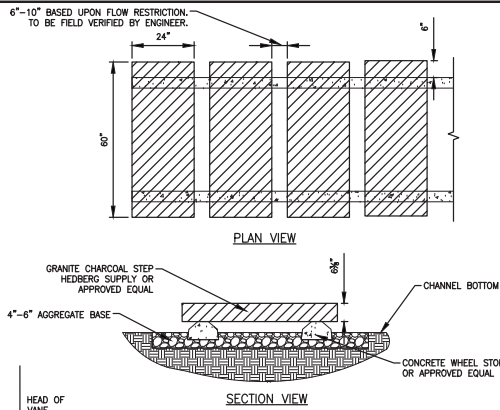
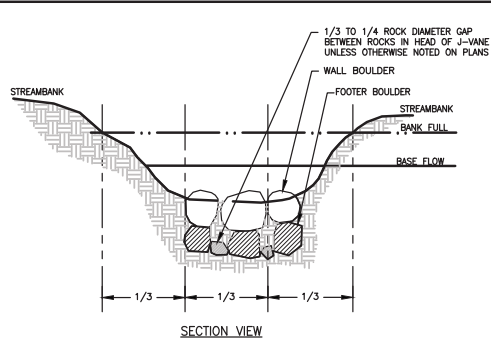
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**PLYMOUTH CREEK CHANNEL RECONSTRUCTION**

CITY OF PLYMOUTH

3400 PLYMOUTH BOULEVARD  
PLYMOUTH, MN 55447

SHEET TITLE  
**DETAILS**

DWN BY	CHK'D	APP'D	DWG DATE	MAR 2017
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PROJECT NO.	SHEET NO.	SHEET NO.		REV NO.
1756-10	D-104	D-104		1



NOTES:

10' JOIST SPAN, 10' POST SPACING

#2 SOUTHERN PINE PRESSURE TREATED



JOISTS = 2"x6" @ 19.33" O.C.

BEAMS = 2'-2"x10"

CORNER FOOTING = 12" DIA. MIN

INTERMEDIATE FOOTING = 17" DIA. MIN

DECKING = 2"x6"

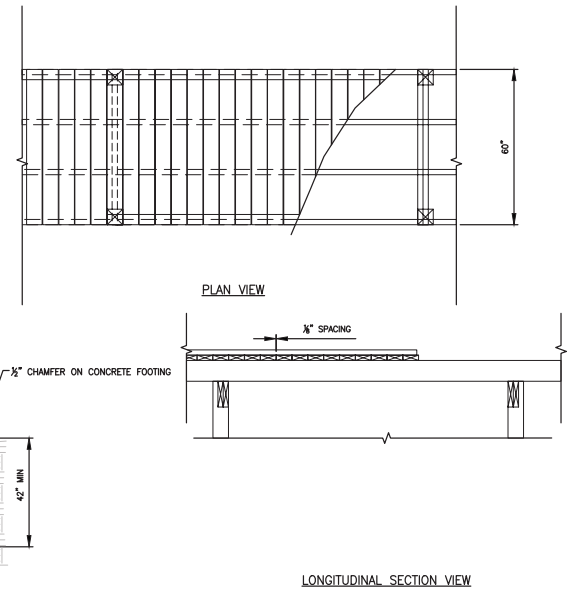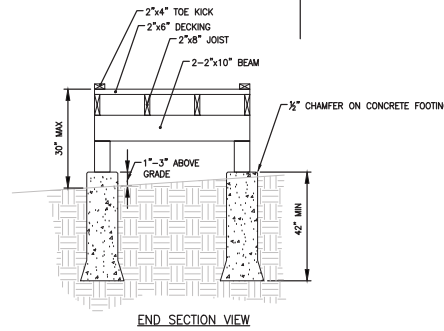

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SHEET TITLE		DETAILS	
DWN BY	CHK'D	APP'D	DWG DATE
SJB	LNJ	EAM	MAR 2017
PROJECT NO.	SHEET NO.	SCALE	AS SHOWN
1756-10	D-105		
			REV NO.
			1