


MEDLEY PARK STORMWATER IMPROVEMENT

CITY OF GOLDEN VALLEY

GOLDEN VALLEY, MN

CITY PROJECT #20-26

Item 6A.
BCWMC 2-17-22

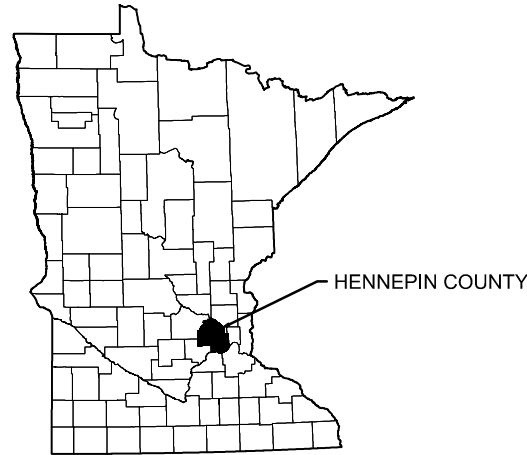

MINNESOTA COUNTY MAP



PROJECT LOCATION MAP



0 100 200
SCALE IN FEET

INDEX OF SHEETS

G-01	TITLE SHEET AND SITE LOCATION MAP
G-02	STATEMENT OF ESTIMATED QUANTITIES
C-01	EXISTING CONDITIONS, PED/TRAFFIC CONTROL, & EROSION CONTROL REMOVALS
C-02	GRADING AND STORM SEWER PLAN
C-03	PONDS AND STORM SEWER PROFILES & SECTIONS *
C-04	PONDS AND STORM SEWER PROFILES & SECTIONS *
C-05	STREAM CHANNEL PLAN AND PROFILE *
C-06	STREAM CHANNEL SECTIONS AND DETAILS *
C-07	BITUMINOUS TRAIL PAVING PLAN *
C-08	DETAILS - BITUMINOUS TRAIL, CONCRETE PAD, AND BENCH
C-09	DETAILS - STORM SEWER
C-10	DETAILS - SITE FEATURES
C-11	DETAILS - SITE FEATURES
SW-01	STORMWATER POLLUTION PREVENTION PLAN (SWPPP)
SW-02	STORMWATER POLLUTION PREVENTION PLAN (SWPPP)
SW-03	EROSION & SEDIMENT CONTROL DETAILS
SW-04	EROSION & SEDIMENT CONTROL DETAILS
B-01	SOIL BORING LOGS

* DRAWING NOT INCLUDED IN THIS SET

PROJECT CONTACTS:

KATIE TURPIN-NAGEL, PE
BARR ENGINEERING CO.
PHONE: 952-446-5725
FAX: 952-832-2601
EMAIL: KJN2@BARR.COM

JEFF OLIVER, PE
CITY OF GOLDEN VALLEY
PHONE: 763-593-8034
EMAIL: JOLIVER@GOLDENVALLEYMN.GOV

KURT LEUTHOLD, PE
BARR ENGINEERING CO.
PHONE: 952-832-2859
FAX: 952-832-2601
EMAIL: KAL@BARR.COM

ERIC ECKMAN
CITY OF GOLDEN VALLEY
PHONE: 763-593-8084
EMAIL: EECKMAN@GOLDENVALLEYMN.GOV

COORDINATE SYSTEM: HENNEPIN COUNTY
HORIZONTAL DATUM: NAD83 (2011)
VERTICAL DATUM: NAVD88



GOPHER STATE ONE CALL:
CALL BEFORE YOU DIG.
1-800-252-1166

I HEREBY CERTIFY THAT THIS PLAN WAS PREPARED BY ME OR UNDER MY DIRECT SUPERVISION AND THAT I AM A DULY LICENSED PROFESSIONAL ENGINEER UNDER LAWS OF THE STATE OF MINNESOTA.

JEFF OLIVER, PE, CITY ENGINEER
DATE _____ REG. NO. 23110


50% DESIGN
NOT FOR CONSTRUCTION

CADD USER: Greg Nelson FILE: I:\DESIGN\23271901_00\23271901_00_TITLESHEET.DWG PLOT SCALE: 1:2 PLOT DATE: 2/1/2022 2:31 PM

				I HEREBY CERTIFY THAT THIS PLAN, SPECIFICATION, OR REPORT WAS PREPARED BY ME OR UNDER MY DIRECT SUPERVISION AND THAT I AM A DULY LICENSED PROFESSIONAL ENGINEER UNDER THE LAWS OF THE STATE OF MINNESOTA.				CLIENT BID CONSTRUCTION		12/10/21				Scale AS SHOWN		BARR PROJECT No. 23/27-1901.00	
				PRINTED NAME				RELEASED TO/FOR		A B C 0 1 2 3		Date 12/10/2021		CITY OF GOLDEN VALLEY GOLDEN VALLEY, MN		CLIENT PROJECT No. 20-26	
				SIGNATURE				DATE RELEASED				Checked KJN2		MEDLEY PARK STORMWATER IMPROVEMENT		DWG. No. G-01	
				DATE _____ LICENSE # _____								Designed BARR		TITLE SHEET AND SITE LOCATION MAP		REV. No. A	
												Approved KAL					



Corporate Headquarters:
Minneapolis, Minnesota
Ph: 1-800-632-2277

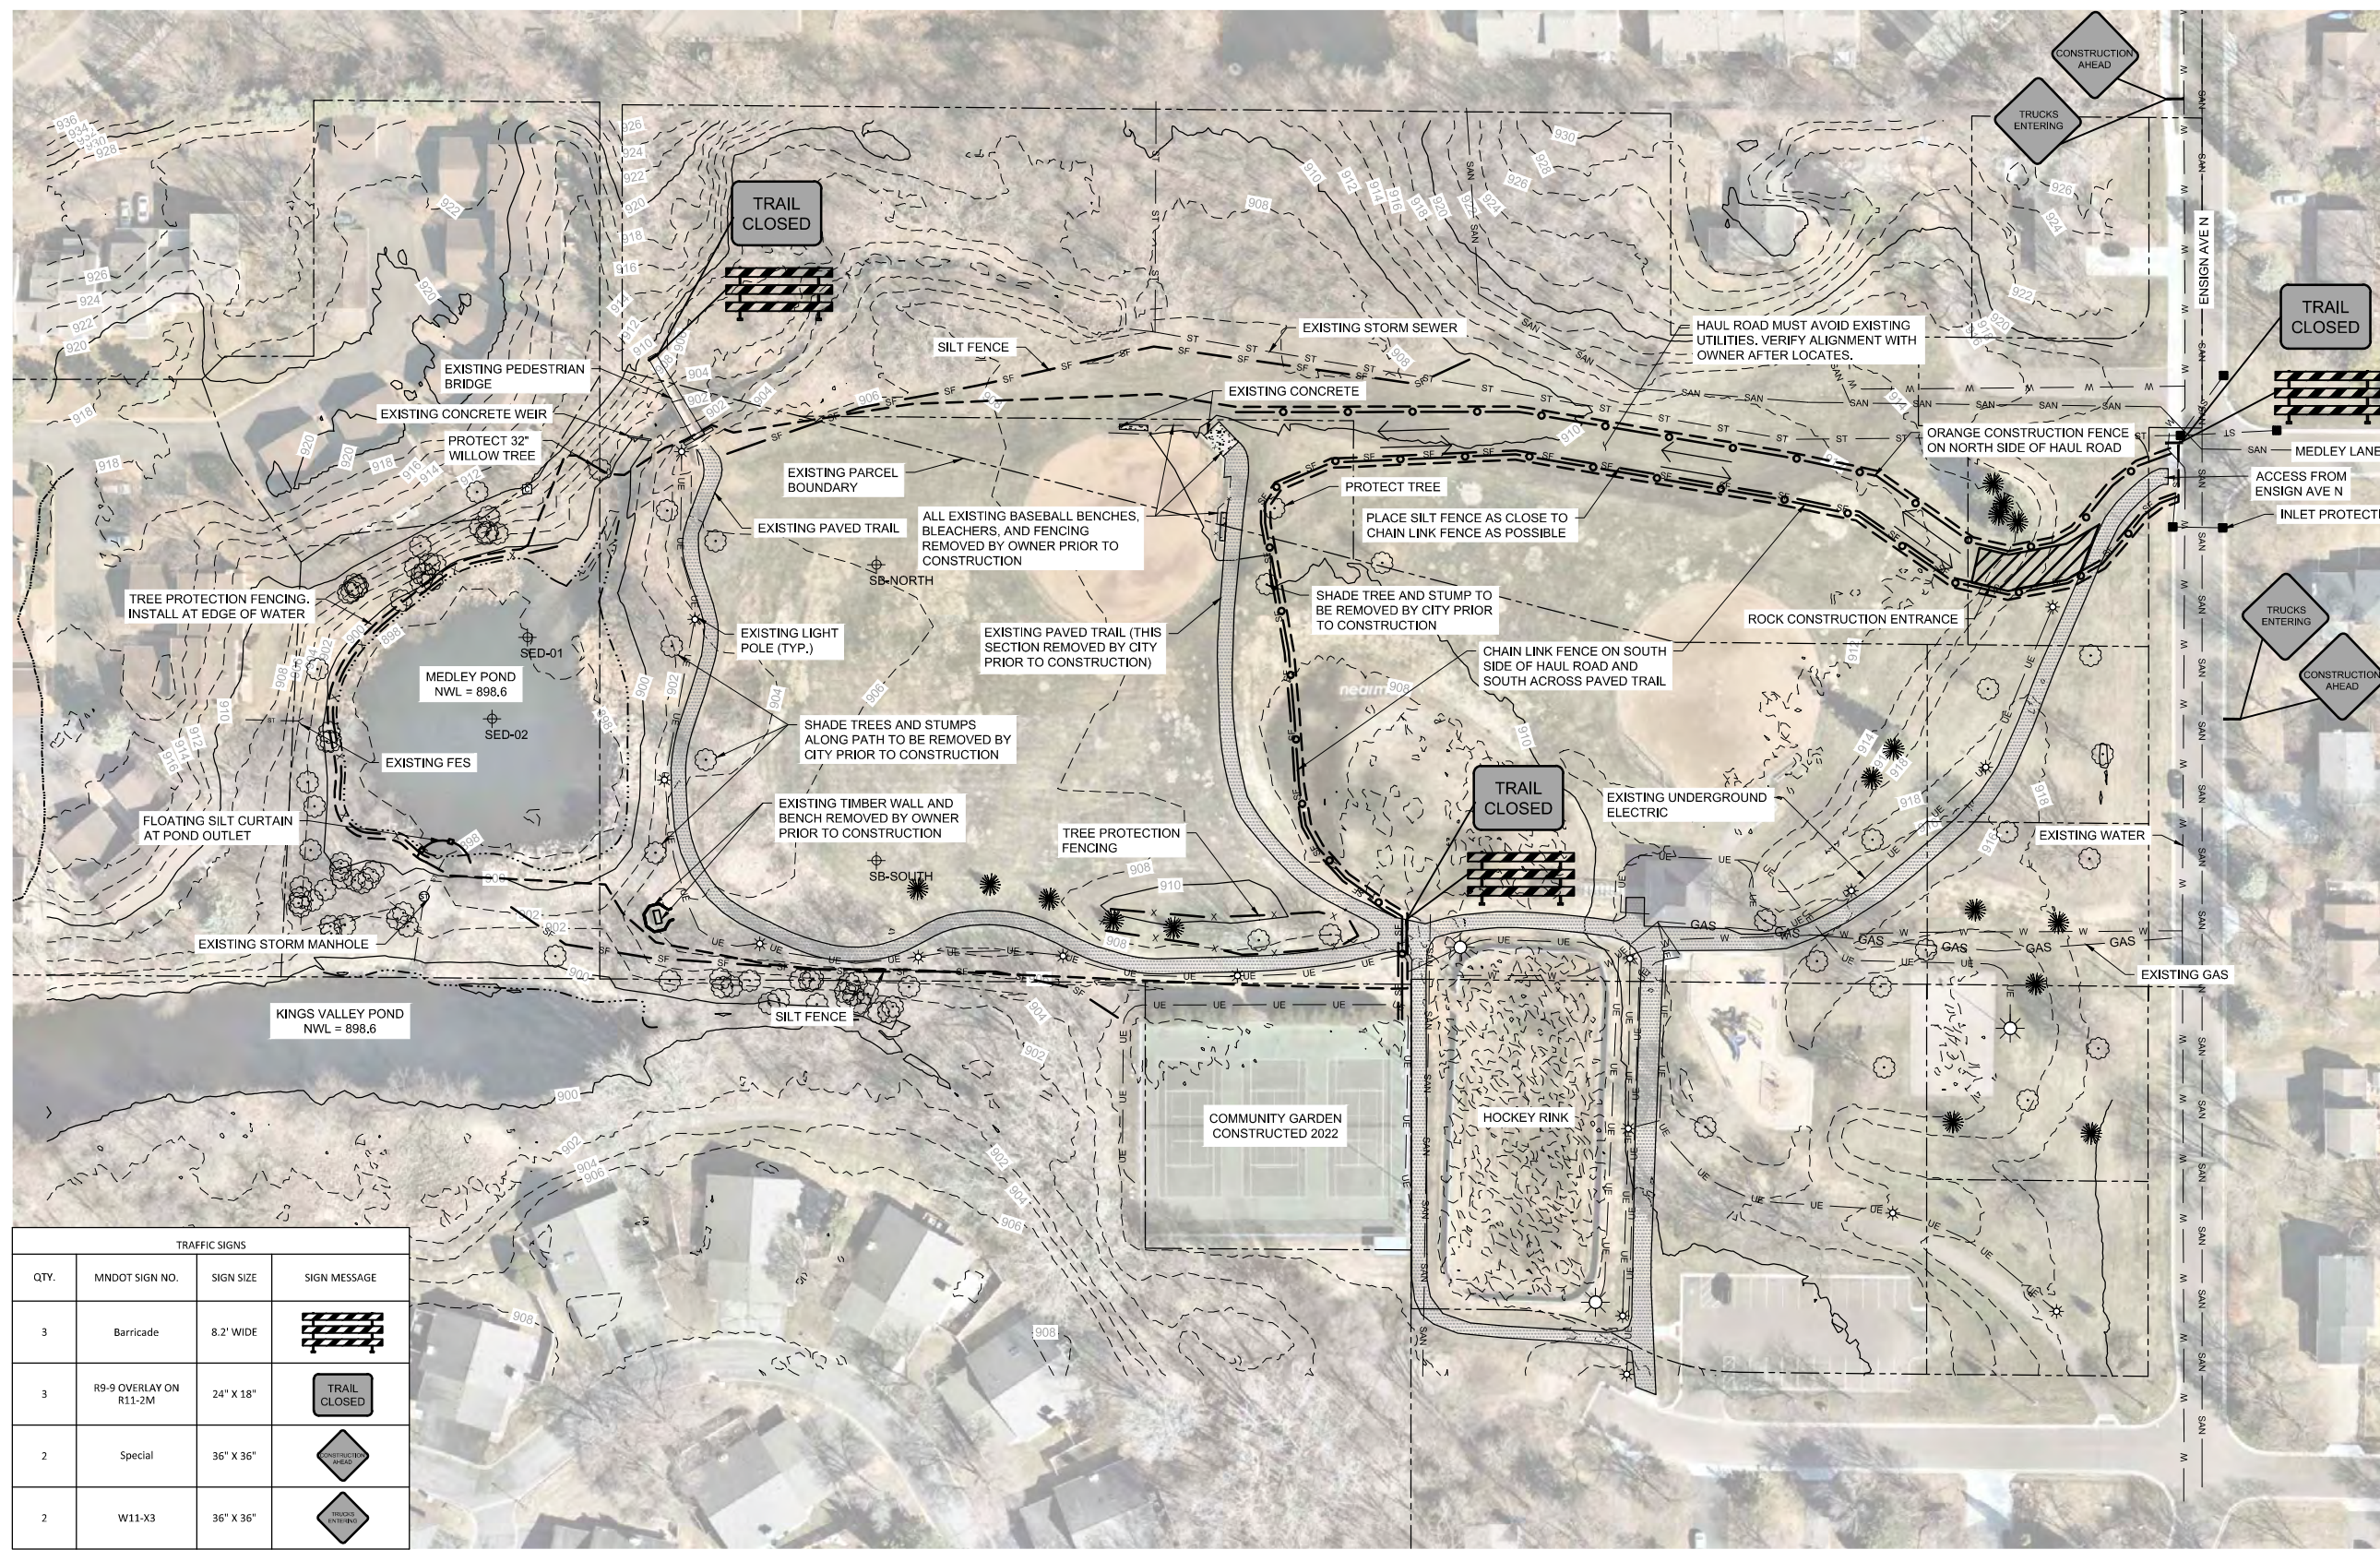

- EXISTING CONDITIONS LEGEND**
- 910 — 10-FT CONTOUR
 - - - 908 - - - 5-FT CONTOUR
 - - - - - PROPERTY LINE
 - - - - - NORMAL WATER LEVEL
 - ST - ST - STORM SEWER
 - SAN - SAN - SANITARY SEWER
 - W - W - WATER
 - GAS - GAS - GAS
 - UE - UE - UNDERGROUND ELECTRIC
 - X - X - FENCELINE
 - ⊕ STORM SEWER MANHOLE
 - ⊙ LIGHT POLE
 - DECIDUOUS TREE
 - ⊙ CONIFEROUS TREE
 - ⊕ SOIL BORING
 - ▒ CONCRETE
 - ▒ BITUMINOUS TRAIL
- PEDESTRIAN/TRAFFIC CONTROL LEGEND**
- - - CONSTRUCTION LIMITS
 - ○ - ○ CONSTRUCTION FENCING
 - ← → HAUL ROAD
- EROSION CONTROL LEGEND**
- ○ - ○ FLOATING SILT CURTAIN
 - SF - SF - SILT FENCE
 - X - X - TREE PROTECTION FENCING
 - INLET PROTECTION
 - ▒ CONSTRUCTION ENTRANCE

- NOTES:**
- 1) CONFIRM LOCATION OF ALL UNDERGROUND UTILITIES PRIOR TO CONSTRUCTION. NOTIFY OWNER OF ANY DISCREPANCIES.
 - 2) UTILITY LOCATIONS ARE APPROXIMATE. ALL UTILITIES IN THE PROJECT AREA SHOULD BE MARKED AND POTHOLED PRIOR TO EXCAVATION.
 - 3) ALL CONSTRUCTION ACCESS, PHASING, AND STAGING TO BE COORDINATED WITH CITY.
 - 4) A TRAFFIC/PEDESTRIAN CONTROL PLAN SHALL BE SUBMITTED BY THE CONTRACTOR. ALL TRAFFIC/PEDESTRIAN CONTROL DEVICES AND SIGNAGE SHALL CONFORM TO THE MN MUTCD, INCLUDING FIELD MANUAL FOR TEMPORARY TRAFFIC CONTROL LAYOUTS. ALL TRAFFIC CONTROL SIGNS AND BARRICADES SHALL BE PLACED BY CONTRACTOR AND APPROVED BY THE CITY.
 - 5) UTILITY RELOCATION TO BE COORDINATED BY CONTRACTOR PRIOR TO CONSTRUCTION.
 - 6) PROTECT ALL EXISTING UTILITIES DURING DEMOLITION AND CONSTRUCTION.
 - 7) EROSION AND SEDIMENT CONTROL MEASURES SHALL BE INSTALLED BEFORE COMMENCING LAND DISTURBING ACTIVITIES AND SHALL NOT BE REMOVED UNTIL PERMANENT COVER HAS BEEN ESTABLISHED. SEE SWPPP.
 - 8) CONTRACTOR SHALL BE RESPONSIBLE FOR PROPER OPERATION, MAINTENANCE, AND REGULAR INSPECTION OF ALL EROSION AND SEDIMENT CONTROL MEASURES UNTIL THE SITE IS FULLY RESTORED.
 - 9) SOIL STOCKPILES SHALL BE STABILIZED WITH MULCH (SUCH AS STRAW MULCH, SLASH MULCH, WOOD CHIP, OR OTHER APPROPRIATE MULCH). IF SLOPES GREATER THAN 3H:1V, COVER MATERIAL WITH TARPS, PLASTIC SHEETING, OR EQUIVALENT MEASURES.
 - 10) IF SEDIMENT IS TRACKED ONTO CITY STREETS, STREET SWEEPING SHALL BE DEPLOYED. SEDIMENT SHALL BE REMOVED BY SWEEPING WITHIN 24 HOURS.
 - 11) FOR SWPPP, SEE SW-01 AND SW-02.
 - 12) FOR EROSION CONTROL NOTES AND DETAILS, SEE SW-03 AND SW-04.
 - 13) FOR SOIL BORING LOGS, SEE B-01.

TRAFFIC SIGNS			
QTY.	MNDOT SIGN NO.	SIGN SIZE	SIGN MESSAGE
3	Barricade	8.2' WIDE	
3	R9-9 OVERLAY ON R11-2M	24" X 18"	
2	Special	36" X 36"	
2	W11-X3	36" X 36"	

1 PLAN: EXISTING CONDITIONS, PED/TRAFFIC CONTROL & EROSION CONTROL




COORDINATE SYSTEM: HENNEPIN COUNTY
 HORIZONTAL DATUM: NAD83 (2011)
 VERTICAL DATUM: NAVD88

50% DESIGN
 NOT FOR CONSTRUCTION

CADD USER: Greg Nelson FILE: I:\DESIGN\23271901_00\23271901_00_EXISTINGCON_PEDTRAFFICCONTROL.DWG PLOT SCALE: 1:2 PLOT DATE: 2/10/2022 1:15 PM

I HEREBY CERTIFY THAT THIS PLAN, SPECIFICATION, OR REPORT WAS PREPARED BY ME OR UNDER MY DIRECT SUPERVISION AND THAT I AM A DULY LICENSED PROFESSIONAL ENGINEER UNDER THE LAWS OF THE STATE OF MINNESOTA.				CLIENT: 2/10/21 BID: _____ CONSTRUCTION: _____								Scale: AS SHOWN Date: 12/10/2021 Drawn: BARR Checked: KJN2 Designed: BARR Approved: KAL				CITY OF GOLDEN VALLEY GOLDEN VALLEY, MN				MEDLEY PARK STORMWATER IMPROVEMENT				BARR PROJECT No. 23/27-1901.00			
PRINTED NAME: _____ SIGNATURE: _____ DATE: _____ LICENSE # _____				RELEASED TO/ FOR: _____ DATE RELEASED: _____								EXISTING CONDITIONS PED/TRAFFIC CONTROL & EROSION CONTROL				CLIENT PROJECT No. 20-26											
NO. BY CHK. APP. DATE REVISION DESCRIPTION				A AD62 KJN2 KAL 12/10/2021 ISSUED FOR REVIEW				DWG. No. C-01				REV. No. A															

CADD USER: Greg Nelson FILE: I:\DESIGN\23271901_00\23271901_00_REMOVALS.DWG PLOT SCALE: 1/2" = 1' PLOT DATE: 2/1/2022 1:16 PM

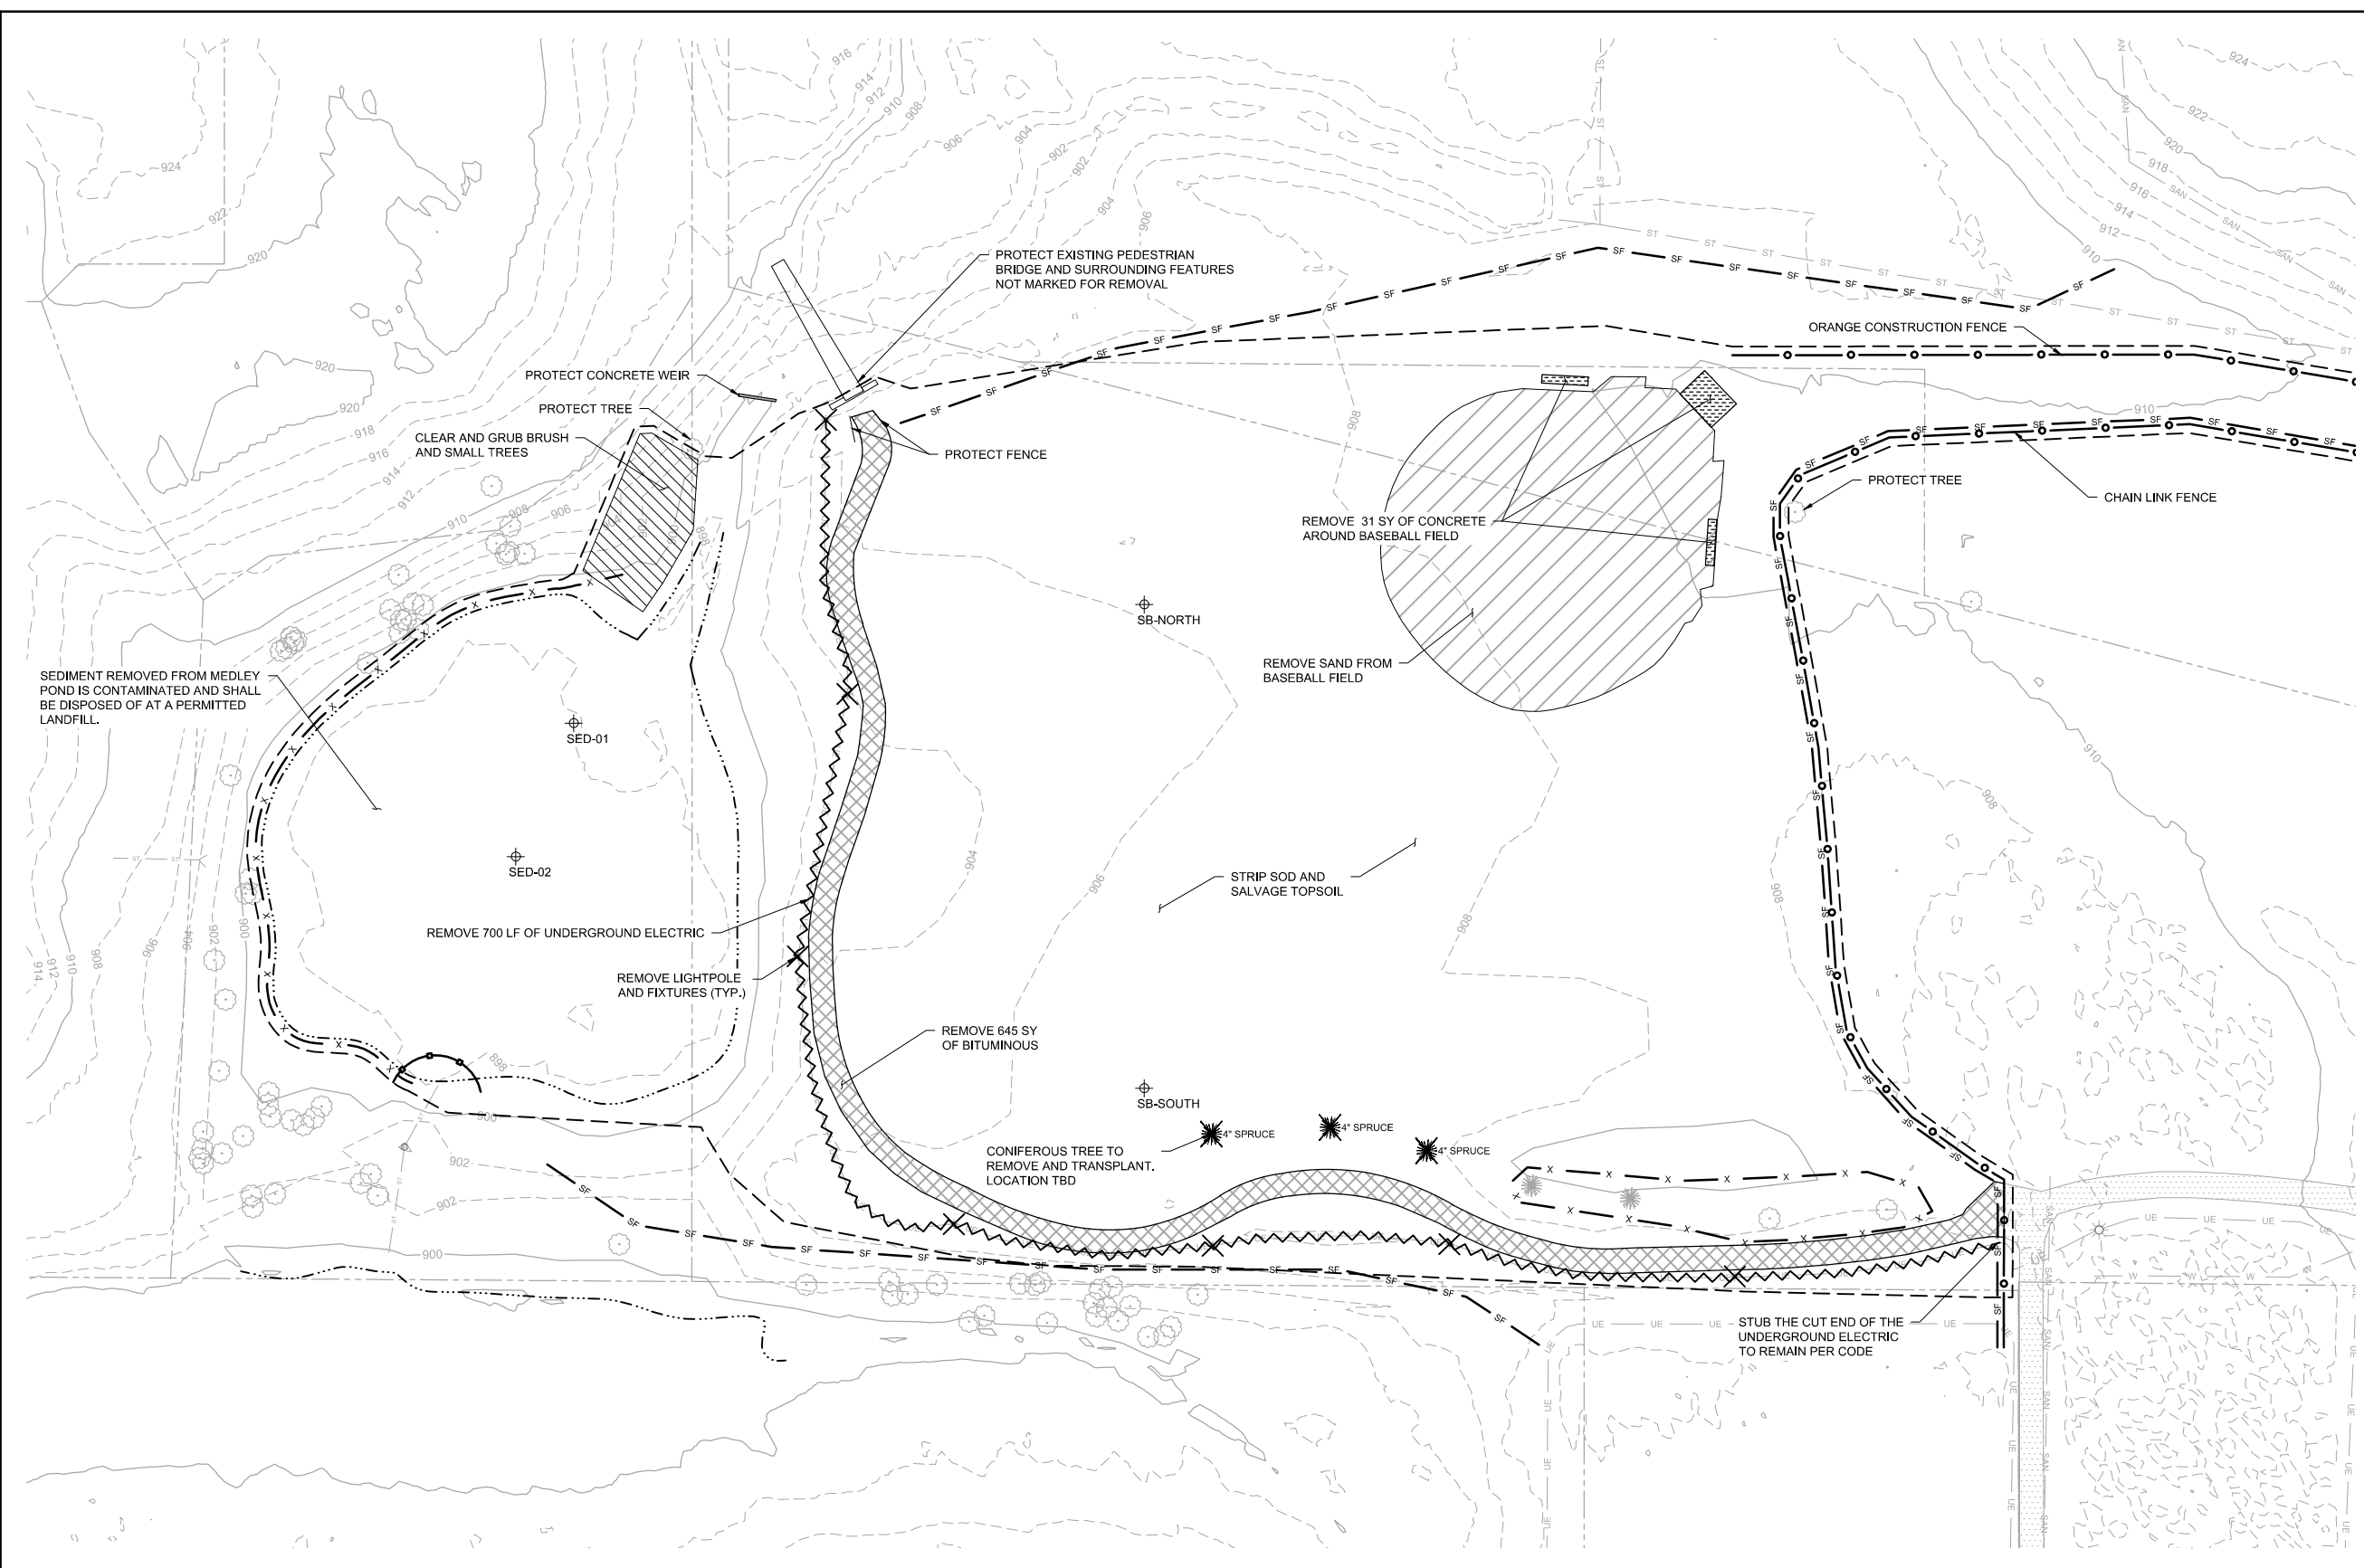

EXISTING CONDITIONS LEGEND

— 910 —	10-FT CONTOUR
- - - 908 - - -	5-FT CONTOUR
— — — — —	PROPERTY LINE
— · · · · ·	NORMAL WATER LEVEL
— ST — ST —	STORM SEWER
— SAN — SAN —	SANITARY SEWER
— W — W —	WATER
— GAS — GAS —	GAS
— UE — UE —	UNDERGROUND ELECTRIC
— X — X —	FENCELINE
⊙	STORM SEWER MANHOLE
⊙	LIGHT POLE
⊙	DECIDUOUS TREE
⊙	CONIFEROUS TREE
⊕	SOIL BORING
[Hatched Box]	CONCRETE
[Hatched Box]	BITUMINOUS TRAIL

REMOVALS LEGEND

— · · · · ·	CONSTRUCTION LIMITS
~ ~ ~ ~ ~	UTILITY REMOVAL
⊙	CONIFEROUS TREE TO REMOVE AND TRANSPLANT
⊕	LIGHT POLE REMOVAL
[Hatched Box]	SAND REMOVAL
[Hatched Box]	CONCRETE REMOVAL
[Hatched Box]	BITUMINOUS REMOVAL
[Hatched Box]	CLEARING AND GRUBBING

PEDESTRIAN/TRAFFIC CONTROL LEGEND

— ○ — ○ —	CONSTRUCTION FENCING
→ → →	HAUL ROAD

EROSION CONTROL LEGEND

— ○ — ○ —	FLOATING SILT CURTAIN
— SF — SF —	SILT FENCE
— X — X —	TREE PROTECTION FENCING
■	INLET PROTECTION
[Hatched Box]	CONSTRUCTION ENTRANCE

- NOTES:**
- 1) CONFIRM LOCATION OF ALL UNDERGROUND UTILITIES PRIOR TO CONSTRUCTION. NOTIFY OWNER OF ANY DISCREPANCIES.
 - 2) UTILITY LOCATIONS ARE APPROXIMATE. ALL UTILITIES IN THE PROJECT AREA SHOULD BE MARKED AND POTHOLED PRIOR TO EXCAVATION.
 - 3) UTILITY RELOCATION TO BE COORDINATED BY CONTRACTOR PRIOR TO CONSTRUCTION.
 - 4) PROTECT ALL EXISTING UTILITIES DURING DEMOLITION AND CONSTRUCTION.
 - 5) DEMOLITION DEBRIS SHALL BE DISPOSED AT APPROPRIATE, LICENSED LANDFILLS.
 - 6) LIGHT POLES AND FIXTURES WITHIN CONSTRUCTION LIMITS SHALL BE REMOVED AND NEW LIGHT POLES/FIXTURES INSTALLED. FOR LIGHT POLES OUTSIDE OF DISTURBANCE LIMITS, FIXTURES SHALL BE REMOVED FROM POLES AND SHALL BE REPLACED WITH NEW FIXTURES. POLES SHALL BE PROTECTED. SEE E-01.

**50% DESIGN
NOT FOR CONSTRUCTION**



I HEREBY CERTIFY THAT THIS PLAN, SPECIFICATION, OR REPORT WAS PREPARED BY ME OR UNDER MY DIRECT SUPERVISION AND THAT I AM A DULY LICENSED PROFESSIONAL ENGINEER UNDER THE LAWS OF THE STATE OF MINNESOTA.				CLIENT BID CONSTRUCTION				12/10/21								Scale AS SHOWN Date 12/10/2021 Drawn BARR Checked KJN2 Designed BARR Approved KAL				CITY OF GOLDEN VALLEY GOLDEN VALLEY, MN				BARR PROJECT No. 23/27-1901.00 CLIENT PROJECT No. 20-26 DWG. No. C-02 REV. No. A			
PRINTED NAME: _____ SIGNATURE: _____ DATE: _____ LICENSE # _____				RELEASED TO/FOR: _____				DATE RELEASED: _____								MEDLEY PARK STORMWATER IMPROVEMENT REMOVALS											
NO. BY CHK. APP. DATE REVISION DESCRIPTION				A ADB2 KJN2 KAL 12/10/2021 ISSUED FOR REVIEW				A B C 0 1 2 3				REMOVALS															

NOTES:


- 1) CONFIRM LOCATION OF ALL UNDERGROUND UTILITIES PRIOR TO CONSTRUCTION. NOTIFY OWNER OF ANY DISCREPANCIES.
- 2) UTILITY LOCATIONS ARE APPROXIMATE. ALL UTILITIES IN THE PROJECT AREA SHOULD BE MARKED AND POTHOLED PRIOR TO EXCAVATION.
- 3) PROTECT ALL EXISTING UTILITIES DURING DEMOLITION AND CONSTRUCTION.
- 4) FOR EROSION/SEDIMENT CONTROL PLAN, SWPPP, AND DETAILS, SEE C-01, SW-01 TO SW-03.
- 5) FOR BITUMINOUS TRAIL PAVING PLAN, SEE C-08.
- 6) FOR SOIL BORING LOGS, SEE B-01.
- 7) FOR ELECTRICAL PLAN, SEE E-01.
- 8) CONTRACTOR SHALL SUBMIT DEWATERING PLAN.
- 9) REMOVE ALL ORGANIC VEGETATIVE SOILS AND MUCK TO CONSTRUCT BERM.

EXISTING CONDITIONS LEGEND

- 890 5 FT CONTOUR
- 889 1 FT CONTOUR
- PROPERTY LINE
- NORMAL WATER LEVEL
- STORM SEWER
- UNDERGROUND ELECTRIC
- FENCELINE
- WOOD TIMBERS
- STORM SEWER MANHOLE
- LIGHT POLE
- DECIDUOUS TREE - DIAMETER
- CONIFEROUS TREE - DIAMETER
- SOIL BORING

CONSTRUCTION LEGEND

- GRADING LIMITS
- 890 5 FT CONTOUR
- 889 1 FT CONTOUR
- X 907.00 SPOT ELEVATION
- BITUMINOUS TRAIL
- NORMAL WATER LEVEL
- STORM SEWER
- LIGHT POLE

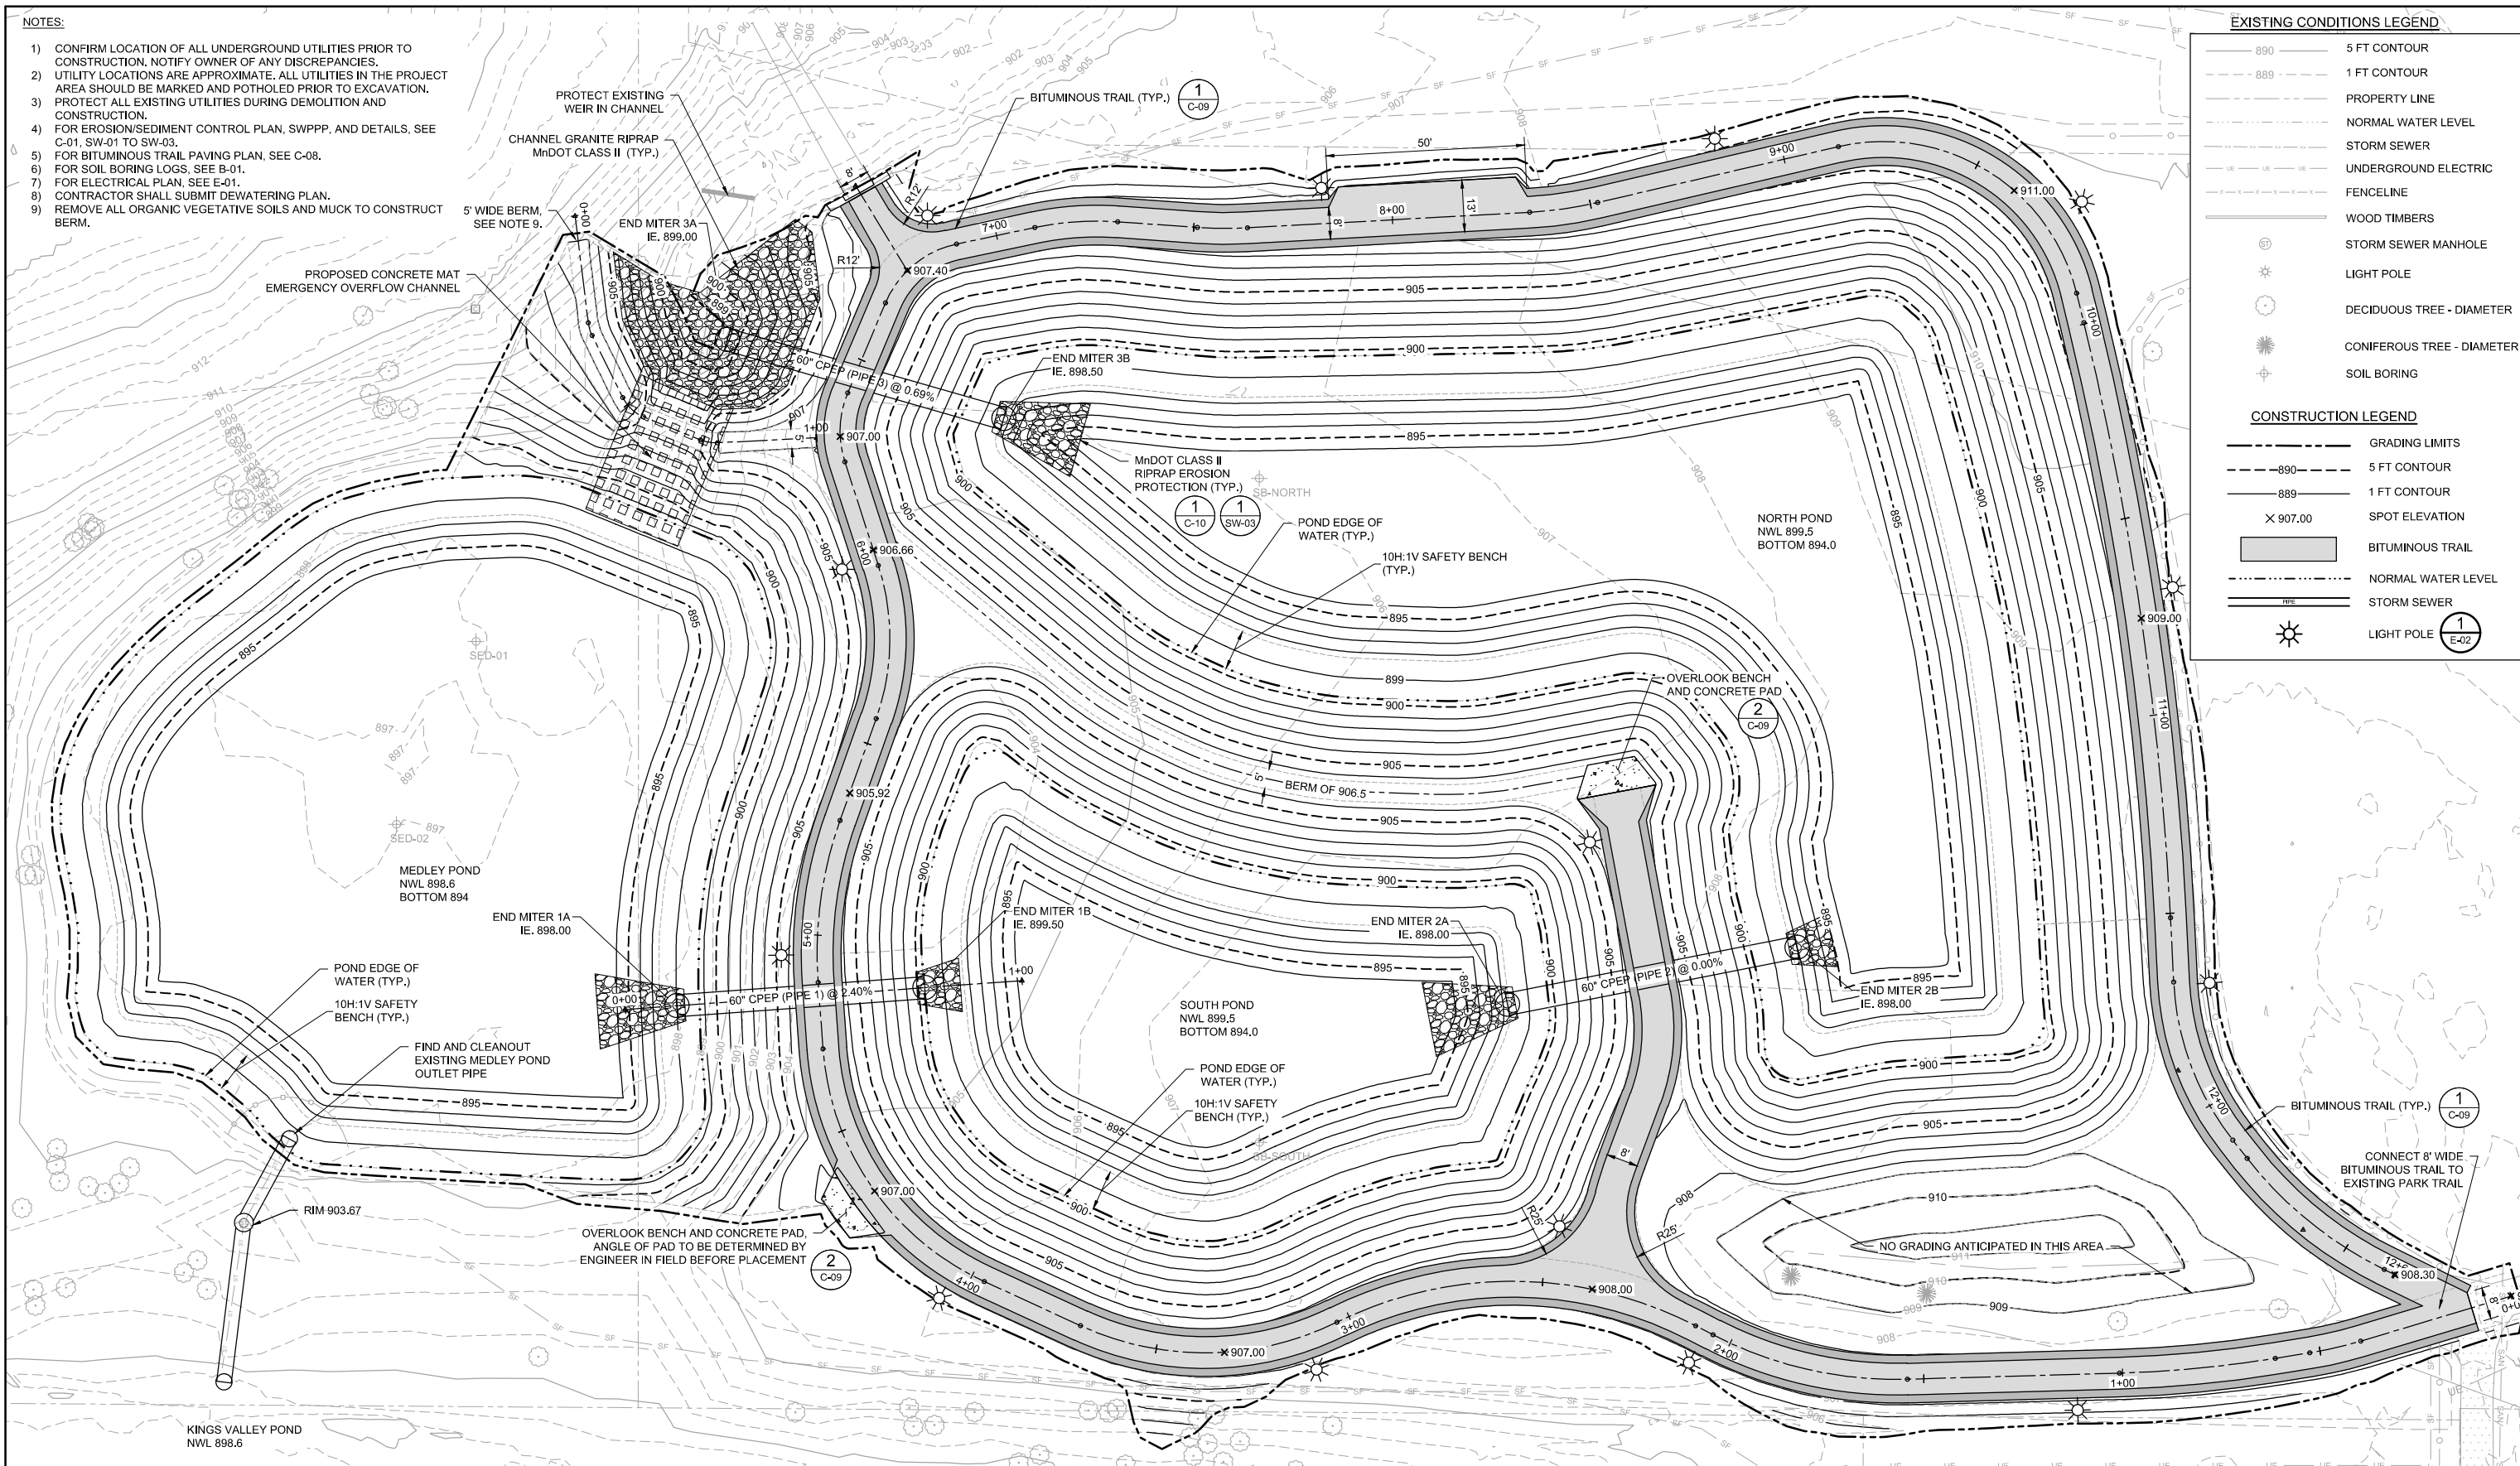

1 PLAN: GRADING AND STORM SEWER



50% DESIGN
NOT FOR CONSTRUCTION

CADD USER: Greg Nelson FILE: M:\DESIGN\23271901_003_Grading and Storm Sewer Plan\DWG PLOT SCALE: 1:2 PLOT DATE: 2/22/2022 9:57 AM

NO.	BY	CHK.	APP.	DATE	REVISION DESCRIPTION
A	GGN	KJN2	KAL	12/10/2021	ISSUED FOR REVIEW

I HEREBY CERTIFY THAT THIS PLAN, SPECIFICATION, OR REPORT WAS PREPARED BY ME OR UNDER MY DIRECT SUPERVISION AND THAT I AM A DULY LICENSED PROFESSIONAL ENGINEER UNDER THE LAWS OF THE STATE OF MINNESOTA.

PRINTED NAME: _____
SIGNATURE: _____
DATE: _____ LICENSE #: _____

CLIENT	12/10/21						
BID							
CONSTRUCTION							
RELEASED TO/FOR	A	B	C	0	1	2	3
DATE RELEASED							





Scale	AS SHOWN
Date	12/10/2021
Drawn	BARR
Checked	KJN2
Designed	BARR
Approved	KAL

CITY OF GOLDEN VALLEY
GOLDEN VALLEY, MN

MEDLEY PARK
STORMWATER IMPROVEMENT
GRADING AND STORM SEWER
PLAN


BARR PROJECT No.	23/27-1901.00
CLIENT PROJECT No.	20-26
DWG. No.	C-03
REV. No.	A

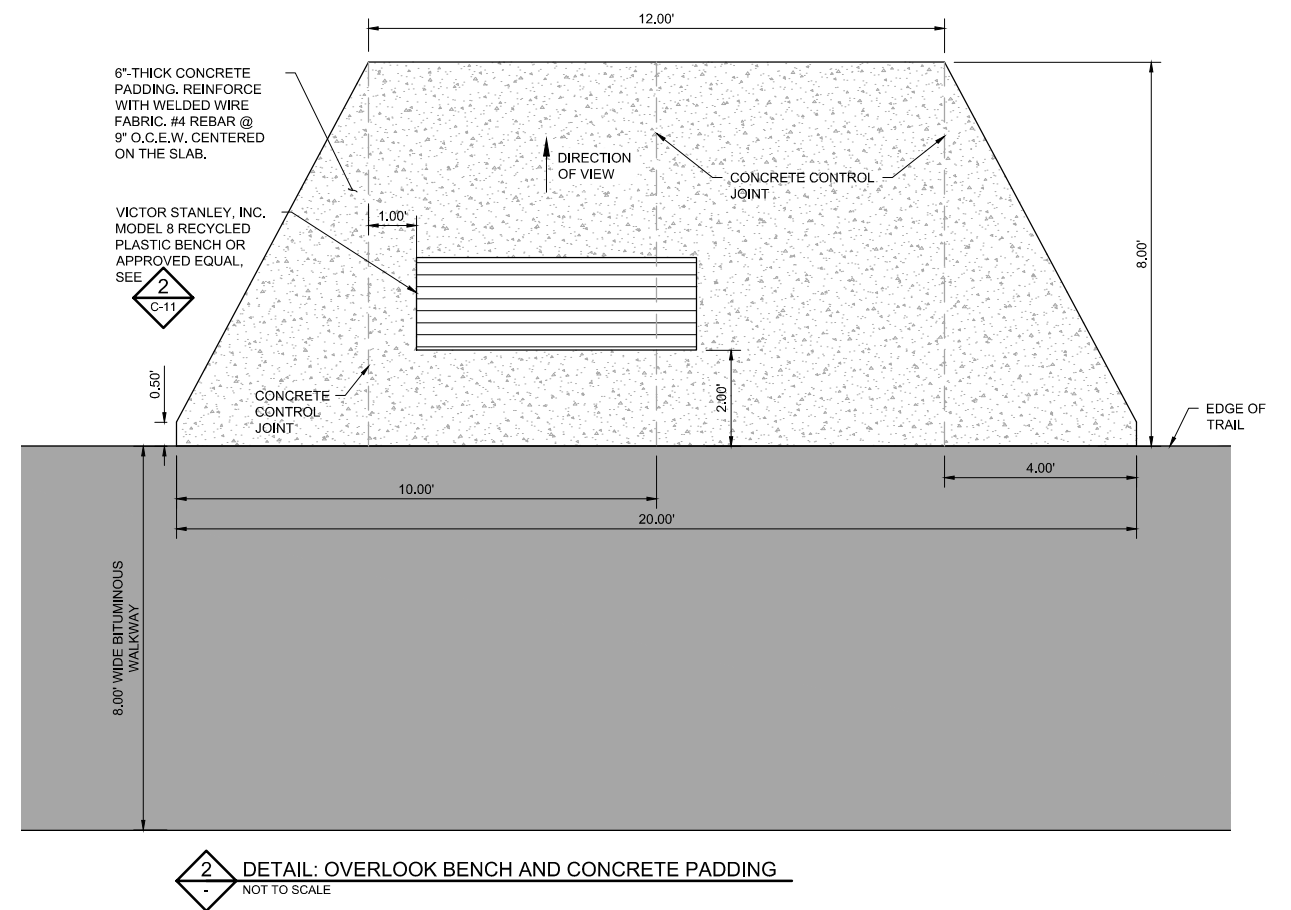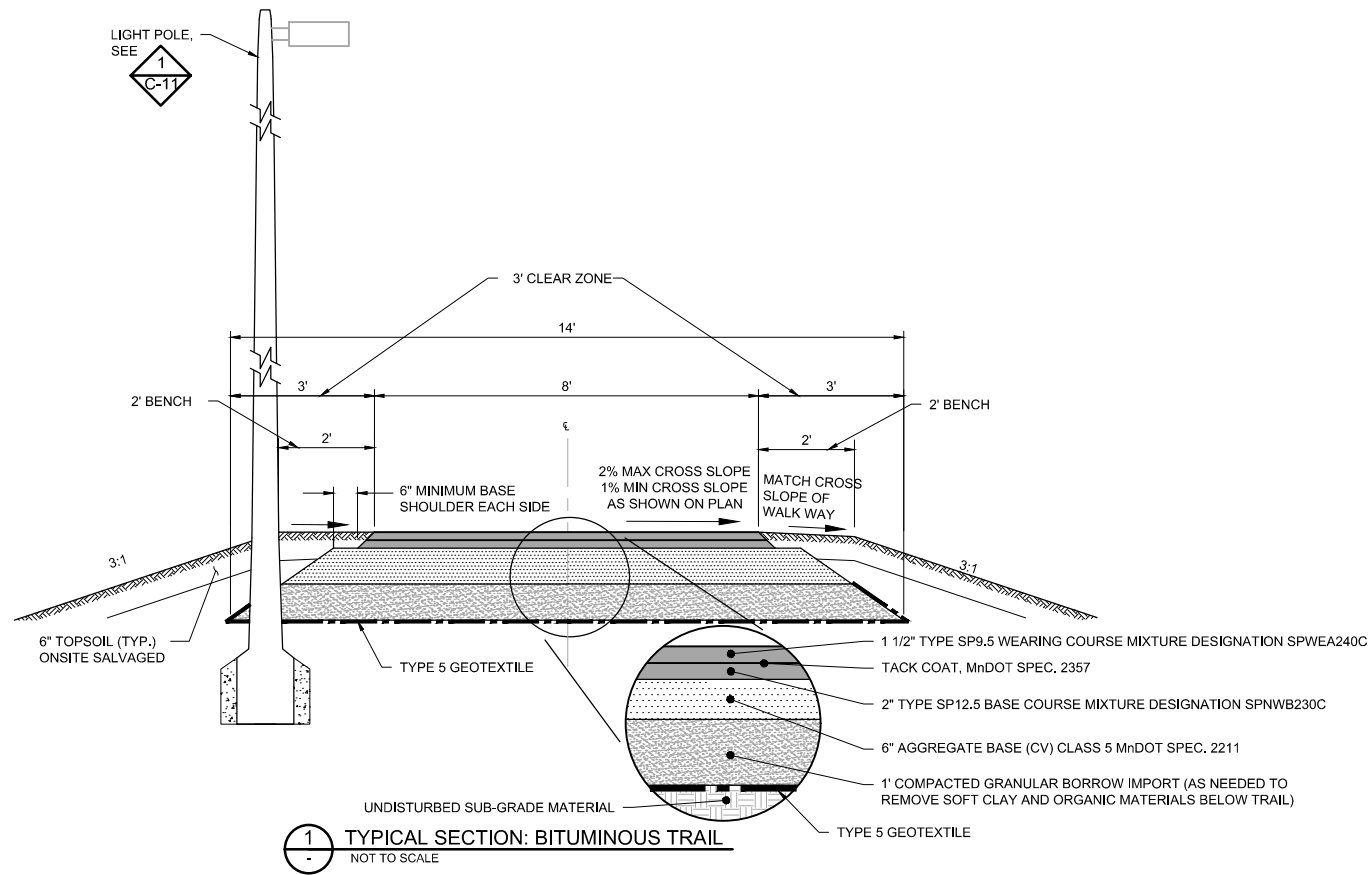


50% DESIGN
NOT FOR CONSTRUCTION

CADD USER: Greg Nelson FILE: I:\DESIGN\23271901_00\23271901_00_C09_TRAIL_DETAILS.DWG PLOT SCALE: 1/2" = 1'-0" PLOT DATE: 2/1/2022 2:18 PM


				I HEREBY CERTIFY THAT THIS PLAN, SPECIFICATION, OR REPORT WAS PREPARED BY ME OR UNDER MY DIRECT SUPERVISION AND THAT I AM A DULY LICENSED PROFESSIONAL ENGINEER UNDER THE LAWS OF THE STATE OF MINNESOTA.				CLIENT BID CONSTRUCTION				12/10/21				 Corporate Headquarters: Minneapolis, Minnesota Ph: 1-800-632-2277		Scale AS SHOWN		CITY OF GOLDEN VALLEY GOLDEN VALLEY, MN		MEDLEY PARK STORMWATER IMPROVEMENT DETAILS - BITUMINOUS TRAIL, CONCRETE PAD, AND BENCH		BARR PROJECT No. 23/27-1901.00	
				PRINTED NAME				RELEASED TO/FOR				Date 12/10/2021		CLIENT PROJECT No. 20-26											
				SIGNATURE				A B C 0 1 2 3				Drawn BARR		DWG. No. C-09											
				DATE				DATE RELEASED				Checked KJN2		REV. No. A											
NO. BY CHK. APP. DATE REVISION DESCRIPTION												Designed BARR													
												Approved KAL													

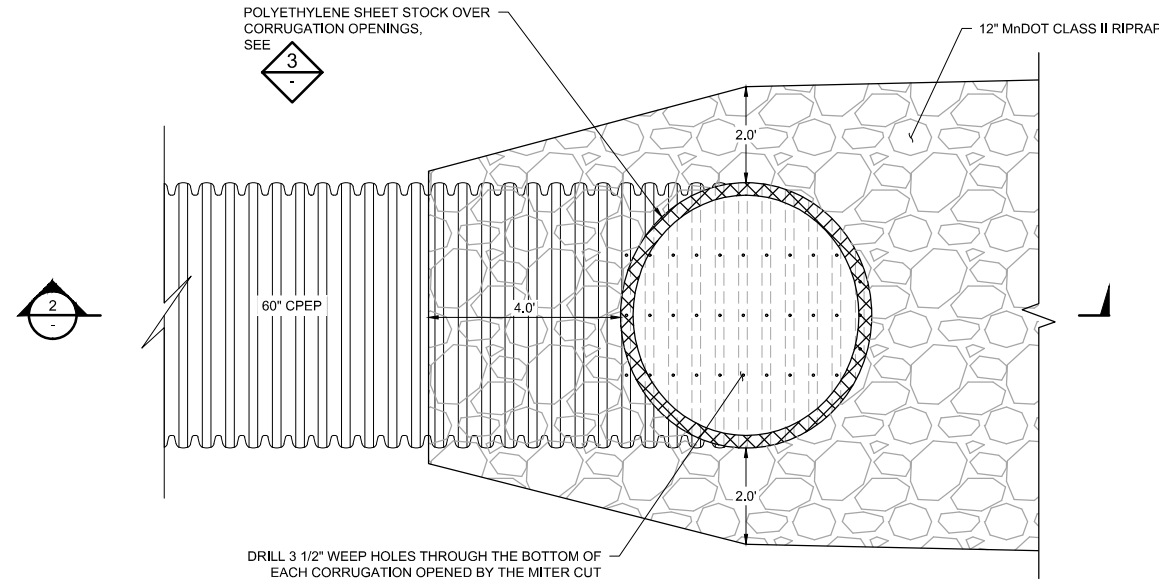


1 PLAN: CUSTOM MITERED CPEP END SECTION
SCALE IN FEET

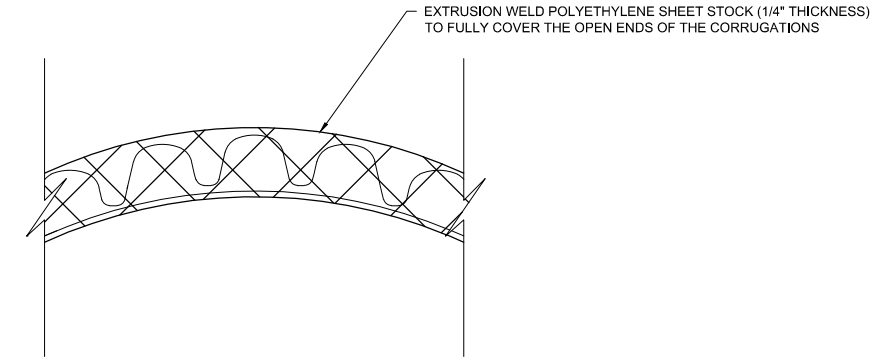

3 DETAIL: POLYETHYLENE SHEET STOCK OVER OPENINGS IN CORRUGATIONS
NOT TO SCALE

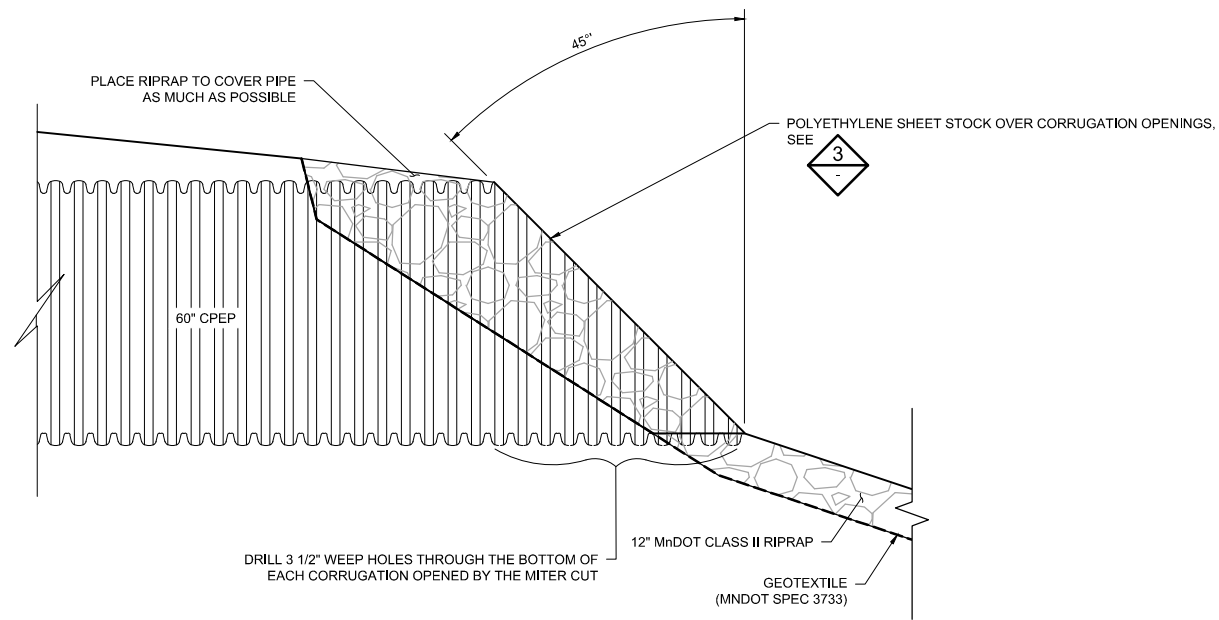

2 SECTION: CUSTOM MITERED CPEP END SECTION
SCALE IN FEET

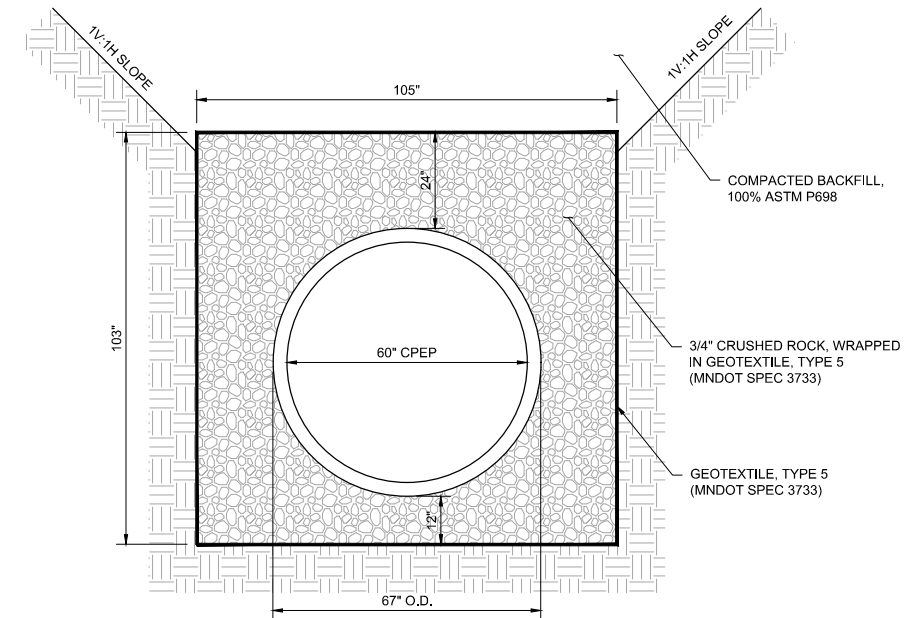


4 DETAIL: INSTALLATION OF 60" CORRUGATED POLYETHYLENE PIPE
NOT TO SCALE


50% DESIGN
NOT FOR CONSTRUCTION

CADD USER: Greg Nelson FILE: I:\DESIGN\23271901_00\23271901_00_C10_STORM_DETAILS.DWG PLOT SCALE: 1:2 PLOT DATE: 2/22/2022 10:14 AM


				I HEREBY CERTIFY THAT THIS PLAN, SPECIFICATION, OR REPORT WAS PREPARED BY ME OR UNDER MY DIRECT SUPERVISION AND THAT I AM A DULY LICENSED PROFESSIONAL ENGINEER UNDER THE LAWS OF THE STATE OF MINNESOTA.				CLIENT BID CONSTRUCTION				12/10/21				 Corporate Headquarters: Minneapolis, Minnesota Ph: 1-800-632-2277		Scale AS SHOWN		CITY OF GOLDEN VALLEY GOLDEN VALLEY, MN		MEDLEY PARK STORMWATER IMPROVEMENT DETAILS - STORM SEWER		BARR PROJECT No. 23/27-1901.00	
				PRINTED NAME				RELEASED TO/FOR				Date 12/10/2021		CLIENT PROJECT No. 20-26											
				SIGNATURE				A B C 0 1 2 3				Drawn BARR		DWG. No. C-10											
				DATE				DATE RELEASED				Checked KJN2		REV. No. A											
A				ADB2 KJN2 KAL 12/10/2021				ISSUED FOR REVIEW				Designed BARR													
				NO. BY CHK. APP. DATE				REVISION DESCRIPTION				Approved KAL													

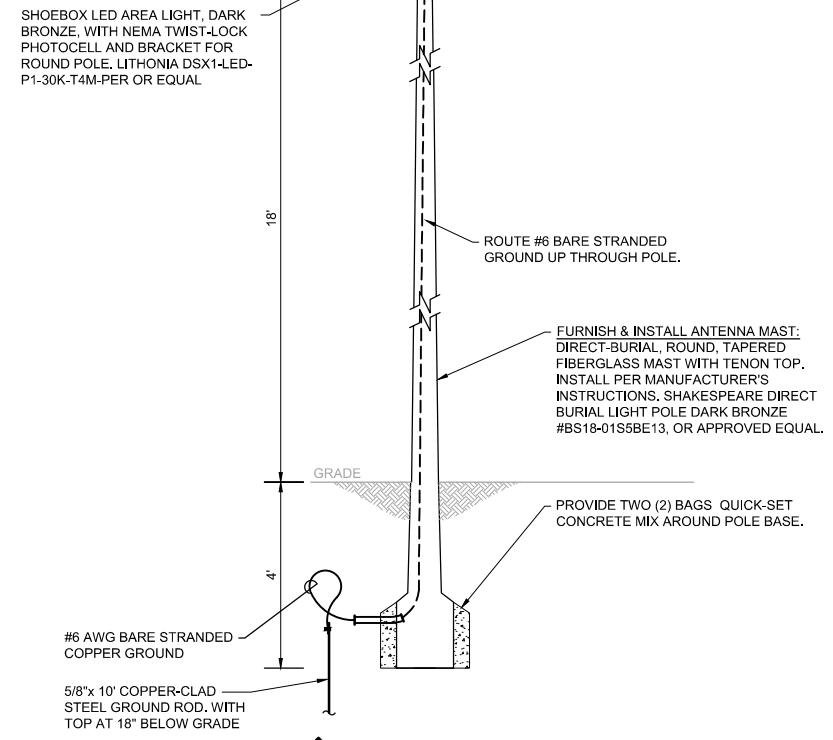

1
-
DETAIL: LIGHT POLE
NOT TO SCALE

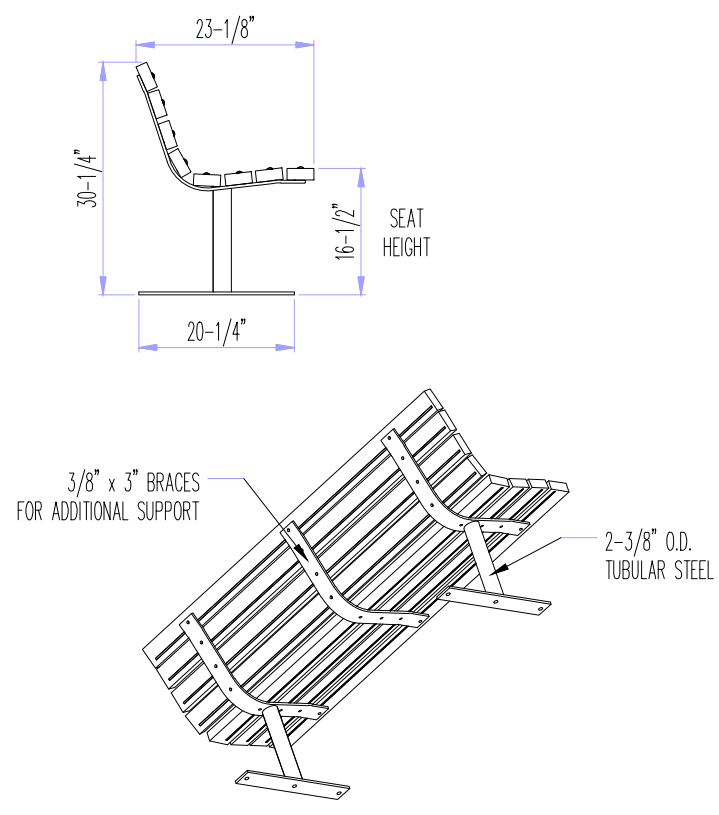

2
-
DETAIL: VICTOR STANLEY, INC. MODEL 8 BENCH
NOT TO SCALE

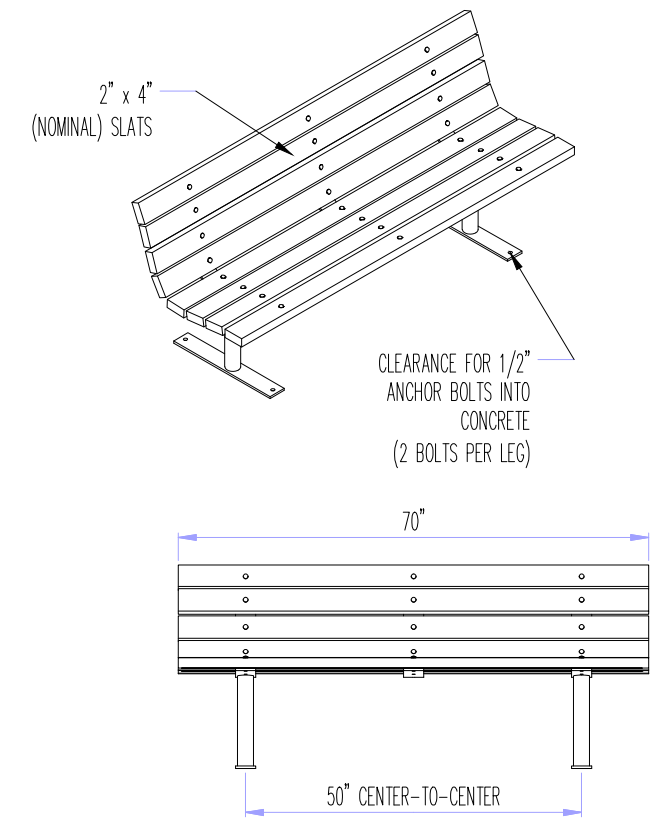

- NOTES:
1. BENCH TYPE
 - 1.1. VICTOR STANLEY, INC. MODEL 8 (HOMESTEAD COLLECTION) OR APPROVED EQUAL
 - 1.1.1. STANDARD 6-FOOT LENGTH
 - 1.1.2. STANDARD 2ND SITE SYSTEMS SLATS (RECYCLED PLASTIC)
 - 1.1.4. SLATS COLOR: MAPLE
 - 1.1.5. STANDARD SURFACE MOUNT
 - 1.1.6. NO ARM RESTS
 2. WINTER SALTING CONSIDERATIONS
 - 2.1. METAL COMPONENTS OF THE BENCH SHOULD BE TREATED FOR HIGH SALT ABUSE. HOT-DIP GALVANIZING BEFORE POWDER COATING IS AVAILABLE AND PERFORMED FOR VICTOR STANLEY, INC. BY AN EXPERIENCED QUALIFIED FIRM. CONTRACTOR TO CONTACT MANUFACTURER FOR DETAILS.
 3. INSTALL BENCH PER MANUFACTURER'S RECOMMENDATIONS.

CADD USER: Greg Nelson FILE: I:\DESIGN\23271901_00\23271901_00_C11_DETAILS.DWG PLOT SCALE: 1/2" PLOT DATE: 2/11/2022 2:20 PM

90% DESIGN
NOT FOR CONSTRUCTION

I HEREBY CERTIFY THAT THIS PLAN, SPECIFICATION, OR REPORT WAS PREPARED BY ME OR UNDER MY DIRECT SUPERVISION AND THAT I AM A DULY LICENSED PROFESSIONAL ENGINEER UNDER THE LAWS OF THE STATE OF MINNESOTA.				CLIENT					Scale AS SHOWN		CITY OF GOLDEN VALLEY GOLDEN VALLEY, MN	MEDLEY PARK STORMWATER IMPROVEMENT DETAILS		BARR PROJECT No.	
				CONSTRUCTION					Date 10/15/2021					23/27-1901.00	
PRINTED NAME				RELEASED TO/FOR				Drawn BARR		CLIENT PROJECT No. 20-26		DWG. No.			
SIGNATURE				DATE RELEASED				Checked				C-11		REV. No.	
DATE				DATE RELEASED				Designed BARR		Approved		A			
REVISION DESCRIPTION															

1.0 GENERAL CONSTRUCTION ACTIVITY INFORMATION:

THIS STORMWATER POLLUTION PREVENTION PLAN (SWPPP) HAS BEEN PREPARED IN COMPLIANCE WITH THE MINNESOTA GENERAL STORMWATER PERMIT FOR CONSTRUCTION ACTIVITY NO. MNR100001 (GENERAL PERMIT), AS REQUIRED BY THE MINNESOTA POLLUTION CONTROL AGENCY (MPCA) UNDER THE NATIONAL POLLUTANT DISCHARGE ELIMINATION SYSTEM/STATE DISPOSAL SYSTEM (NPDES/SDS) PROGRAM.

THE PROJECT IS LOCATED IN THE CITY OF GOLDEN VALLEY, HENNEPIN COUNTY, MINNESOTA. PROPOSED CONSTRUCTION ACTIVITIES WILL TAKE PLACE AT MEDLEY PARK. THE APPROXIMATE CENTROID OF THE PROJECT HAS A LATITUDE OF 45.00519 AND A LONGITUDE OF -93.39679.

THIS PROJECT INVOLVES EROSION CONTROL, CONSTRUCTION OF NEW PONDS, INSTALLATION OF CULVERTS, CONSTRUCTION OF NEW PAVED TRAIL, REPLACEMENT OF LIGHT POLES AND FIXTURES, AND SITE RESTORATION. THE PROJECT AS PROPOSED HAS A TOTAL DISTURBANCE AREA OF 3.58 ACRES. EROSION PREVENTION AND SEDIMENT CONTROL MEASURES ARE REQUIRED TO MINIMIZE SEDIMENT FROM BEING TRANSPORTED INTO THE KINGS VALLEY POND (CITY OF GOLDEN VALLEY POND ML-2), WHICH IS NOT AN IMPAIRED WATER BODY AND FURTHER DOWNSTREAM TO MEDICINE LAKE, WHICH IS AN IMPAIRED WATER BODY. REFER TO PROJECT DRAWINGS FOR FURTHER DETAILS. (CSW PERMIT PART III.A.1)

1.1 PROJECT SIZE AND CUMULATIVE IMPERVIOUS SURFACE:

- THE ANTICIPATED AREA OF DISTURBANCE IS APPROXIMATELY 3.58 ACRES.
• THE TOTAL AREA OF PRE-CONSTRUCTION IMPERVIOUS AREA IS APPROXIMATELY X.XX ACRES.
• THE TOTAL AREA OF POST-CONSTRUCTION IMPERVIOUS AREA IS APPROXIMATELY X.XX ACRES.
• THE TOTAL NEW IMPERVIOUS AREA IS APPROXIMATELY X.XX ACRES.

1.2 DATES OF CONSTRUCTION:

ANTICIPATED START DATE: NOVEMBER, 2022. ANTICIPATED END DATE: JUNE, 2023.

1.3 CONTACT INFORMATION:

OWNER: CITY OF GOLDEN VALLEY
MAILING ADDRESS: 7800 GOLDEN VALLEY RD, GOLDEN VALLEY, MN 55427
CONTACT PERSON: JEFF OLIVER
PHONE NUMBER: 763-593-8034
TITLE: CITY ENGINEER
EMAIL ADDRESS: JOLIVER@GOLDENVALLEYMN.GOV
ALTERNATE CONTACT PERSON: ERIC ECKMAN
PHONE NUMBER: 763-593-8084
TITLE: ENVIRONMENTAL RESOURCES SUPERVISOR
EMAIL ADDRESS: EECKMAN@GOLDENVALLEYMN.GOV

OPERATOR / GENERAL CONTRACTOR (WILL OVERSEE IMPLEMENTATION OF THE SWPPP): TBD

MAILING ADDRESS: TBD
CONTACT PERSON: TBD
PHONE NUMBER: TBD
TITLE: TBD
EMAIL ADDRESS: TBD

PARTY RESPONSIBLE FOR LONG-TERM OPERATION AND MAINTENANCE OF THE PERMANENT STORMWATER MANAGEMENT SYSTEM:

CITY OF GOLDEN VALLEY
MAILING ADDRESS: 7800 GOLDEN VALLEY RD, GOLDEN VALLEY, MN 55427
CONTACT PERSON: AL LUNDSTROM
PHONE NUMBER: 763-593-8046
TITLE: PARK MAINTENANCE SUPERINTENDENT
EMAIL ADDRESS: ALUNDSTROM@GOLDENVALLEYMN.GOV

2.0 RECEIVING WATERS:

WATERS WITHIN ONE MILE (NEAREST STRAIGHT LINE DISTANCE) THAT ARE LIKELY TO RECEIVE STORMWATER RUNOFF FROM THE PROJECT SITE (CSW PERMIT ITEM 5.10) INCLUDE:

Table with 6 columns: NAME OF WATER BODY, TYPE, WATER BODY ID, SPECIAL WATER?, IMPAIRED WATER?, PUBLIC WATER WITH WORK IN WATER RESTRICTIONS?
Rows include Kings Valley Pond (ML-2), ML-3, and Medicine Lake.

- (1) TYPE EXAMPLES: DITCH, POND, WETLAND, CALCAREOUS FEN, LAKE, STREAM, RIVER
(2) WATER BODY IDENTIFICATION (ID) MIGHT NOT BE AVAILABLE FOR ALL WATER BODIES. USE THE SPECIAL AND IMPAIRED WATERS SEARCH TOOL AT: HTTPS://WWW.PCA.STATE.MN.US/WATER/STORMWATER-SPECIAL-AND-IMPAIRED-WATERS-SEARCH
(3) REFER TO CSW PERMIT SECTION 23. IMPAIRED WATER FOR THE FOLLOWING POLLUTANT(S) OR STRESSOR(S): PHOSPHORUS (NUTRIENT EUTROPHICATION BIOLOGICAL INDICATORS), TURBIDITY, TOTAL SUSPENDED SOLIDS (TSS), DISSOLVED OXYGEN, OR AQUATIC BIOTA (FISH BIOASSESSMENT, AQUATIC PLANT BIOASSESSMENT, AND AQUATIC MACROINVERTEBRATE BIOASSESSMENT)

2.1 SPECIAL AND IMPAIRED WATERS: THE MPCA'S SPECIAL AND IMPAIRED WATERS SEARCH TOOL WAS USED TO LOCATE SPECIAL AND IMPAIRED WATERS WITHIN ONE MILE (AERIAL RADIUS MEASUREMENT) OF THE PROJECT SITE. MEDICINE LAKE HAS AN EPA-APPROVED IMPAIRMENT FOR MERCURY IN FISH TISSUE; NUTRIENTS. THESE IMPAIRMENTS ARE CONSIDERED CONSTRUCTION RELATED AND DO REQUIRE ADDITIONAL BEST MANAGEMENT PRACTICES (BMPS) OR PLAN REVIEW FOR COMPLIANCE WITH THE GENERAL PERMIT. (CSW PERMIT ITEM 2.7 AND SECTION 23)

ADDITIONAL BMPS OR OTHER SPECIFIC CONSTRUCTION RELATED IMPLEMENTATION ACTIVITIES IDENTIFIED IN AN APPROVED TOTAL MAXIMUM DAILY LOAD (TMDL) INCLUDE STABILIZING EXPOSED SOIL AREAS WITHIN SEVEN (7) CALENDAR DAYS AFTER THE CONSTRUCTION ACTIVITY IN THAT PORTION OF THE SITE TEMPORARILY OR PERMANENTLY CEASES. (CSW PERMIT ITEM 5.19)

2.2 PUBLIC WATERS WITH WORK IN WATER RESTRICTIONS: THIS PROJECT DOES NOT INCLUDE WORK IN PUBLIC WATERS. (CSW PERMIT ITEM 5.11)

2.3 WETLAND IMPACTS: THIS PROJECT MAY HAVE TEMPORARY ADVERSE IMPACTS TO WETLANDS, INCLUDING: EXCAVATION, DEGRADATION OF WATER QUALITY, DRAINING, PERMANENT INUNDATION, OR FLOODING. PERIMETER SEDIMENT CONTROLS WILL BE INSTALLED DURING CONSTRUCTION TO HELP MITIGATE WATER QUALITY DEGRADATION. THE PROJECT WILL RESULT IN A NET INCREASE IN WETLAND AREA. (CSW PERMIT ITEMS 2.4 AND 2.10, AND SECTION 22)

2.4 ENVIRONMENTAL REVIEW AND OTHER REQUIRED REVIEWS: STORMWATER MITIGATION MEASURES ARE NOT REQUIRED AS A RESULT OF AN ENVIRONMENTAL REVIEW (E.G., EAW OR EIS), ENDANGERED OR THREATENED SPECIES REVIEW, ARCHEOLOGICAL SITE REVIEW, OR OTHER LOCAL, STATE, OR FEDERAL REVIEW CONDUCTED FOR THE PROJECT. (CSW PERMIT ITEMS 2.8, 2.9, AND 5.16)

2.5 KARST AREAS OR DRINKING WATER SUPPLY MANAGEMENT AREAS: THIS PROJECT DOES NOT INCLUDE ANY KARST OR DRINKING WATER SUPPLY MANAGEMENT AREAS. (CSW PERMIT ITEMS 16.19, 16.20, AND 18.10)

3.0 PROJECT PLANS AND SPECIFICATIONS:

REQUIRED FEATURE

Table with 2 columns: REQUIRED FEATURE, SHEET NUMBER
Includes entries for Project Location and Construction Limits, Existing and Final Grades, Soil Types, and Erosion/Sediment Control measures.

4.0 BEST MANAGEMENT PRACTICES (BMPS):

4.1 EROSION PREVENTION PRACTICES:

- 1. BEFORE LAND DISTURBING ACTIVITIES BEGIN, THE LIMITS OF THE AREAS TO BE DISTURBED DURING CONSTRUCTION WILL BE DELINEATED WITH FLAGS, STAKES, SIGNS, SILT FENCE, ETC.
2. TEMPORARY STABILIZATION OF SOILS AND SOIL STOCKPILES: (CSW PERMIT ITEMS 8.4, 8.5, AND 23.9)
3. ENERGY DISSIPATION AT PIPE OUTLETS: ENERGY DISSIPATION AT PIPE OUTLETS WILL BE PROVIDED WITH ONE OR MORE OF THE FOLLOW METHODS: RIP RAP, SPLASH PADS, GABIONS, OR EQUIVALENT MEASURES.
4. EROSION PREVENTION IMPLEMENTATION TIMELINES: (CSW PERMIT ITEMS 5.4, 8.4 THROUGH 8.6, AND 23.9)

4.2 SEDIMENT CONTROL PRACTICES:

- 1. DOWNGRADIENT PERIMETER CONTROLS: (CSW PERMIT ITEMS 9.2 THROUGH 9.6)
a. SEDIMENT CONTROL PRACTICES WILL BE ESTABLISHED ON ALL DOWNGRADIENT PERIMETERS AND LOCATED UPGRADIENT OF ANY BUFFER ZONES.
b. PERIMETER SEDIMENT CONTROL PRACTICES MUST BE INSTALLED BEFORE ANY UPGRADIENT LAND-DISTURBING ACTIVITIES BEGIN AND REMAIN IN PLACE UNTIL PERMANENT COVER HAS BEEN ESTABLISHED.

- c. IF SEDIMENT CONTROL PRACTICES HAVE BEEN ADJUSTED OR REMOVED TO ACCOMMODATE SHORT-TERM ACTIVITIES (SUCH AS CLEARING, GRUBBING, OR PASSAGE OF VEHICLES), THE CONTROLS MUST BE RE-INSTALLED IMMEDIATELY AFTER THE SHORT-TERM ACTIVITY HAS BEEN COMPLETED.
d. IF THE DOWNGRADIENT SEDIMENT CONTROLS ARE OVERLOADED (BASED ON FREQUENT FAILURE OR EXCESSIVE MAINTENANCE REQUIREMENT), INSTALL ADDITIONAL UPGRADIENT SEDIMENT CONTROL PRACTICES OR REDUNDANT BMPS TO ELIMINATE THE OVERLOADING AND AMEND THE SWPPP TO IDENTIFY THESE ADDITIONAL PRACTICES.
2. SOIL STOCKPILE PERIMETER CONTROLS: TEMPORARY SOIL STOCKPILES WILL BE SURROUNDED BY: SILT FENCE, SEDIMENT CONTROL LOGS / BIOROLLS (FILLED WITH COMPOST, WOOD CHIPS, ROCK, ETC.) OR EQUIVALENT MEASURES, AND SHALL NOT BE PLACED IN ANY NATURAL BUFFERS OR SURFACE WATERS.
3. STORM DRAIN INLET PROTECTION: (CSW PERMIT ITEMS 9.7 AND 9.8)
a. INLET PROTECTION BMPS WILL BE INSTALLED AROUND ALL STORM DRAIN INLETS DOWNGRADIENT OF CONSTRUCTION ACTIVITIES.
b. STORM DRAIN INLETS WILL BE PROTECTED UNTIL ALL SOURCES WITH POTENTIAL FOR DISCHARGING TO THE INLET HAVE BEEN STABILIZED.
c. INLET PROTECTION BMPS WILL BE: SEDIMENT CONTROL LOG, FILTER SACK, ROCK WITH FILTER FABRIC, FILTER FENCE BOX OR EQUIVALENT MEASURES.
4. VEHICLE TRACKING BMPS: (CSW PERMIT ITEMS 9.11 AND 9.12)
a. VEHICLE TRACKING BMPS WILL BE INSTALLED TO MINIMIZE THE TRACKING OUT OF SEDIMENT FROM THE CONSTRUCTION AREA AND WILL INCLUDE: ROCK PADS, MUD MATS, OR STEEL WASH RACKS OR AN EQUIVALENT SYSTEM.
b. IF SUCH VEHICLE TRACKING BMPS ARE NOT ADEQUATE TO PREVENT SEDIMENT FROM BEING TRACKED ONTO THE PAVED ROAD, STREET SWEEPING WILL ALSO BE EMPLOYED.
5. PROTECTION OF INFILTRATION AREAS: IF NECESSARY, ADDITIONAL SEDIMENT CONTROLS (E.G., DIVERSION BERMS) WILL BE INSTALLED TO KEEP RUNOFF AWAY FROM PLANNED INFILTRATION AREAS WHEN EXCAVATED PRIOR TO ESTABLISHING PERMANENT COVER WITHIN THE CONTRIBUTING DRAINAGE AREA.
6. MINIMIZATION AND TOPSOIL WILL BE PRESERVED WHERE POSSIBLE.
7. PRIORITIZATION OF ONSITE INFILTRATION AND SEDIMENT REMOVAL: (CSW PERMIT ITEM 9.16)
a. PRIOR TO OFFSITE DISCHARGE, INFILTRATION AND SEDIMENT REMOVAL WILL BE IMPLEMENTED ONSITE WHERE POSSIBLE.
b. DISCHARGES FROM BMPS WILL BE DIRECTED TO VEGETATED AREAS OF THE SITE (INCLUDING ANY NATURAL BUFFERS) IN ORDER TO INCREASE SEDIMENT REMOVAL AND MAXIMIZE STORMWATER INFILTRATION, IF EROSION IS NOTED TO OCCUR AS THE RESULT OF SUCH A DISCHARGE.
8. BUFFER ZONE OR REDUNDANT SEDIMENT CONTROLS TO PROTECT SURFACE WATERS: (CSW PERMIT ITEM 9.17)
a. A 50-FOOT NATURAL BUFFER WILL BE PRESERVED IN CONSTRUCTION AREAS DISCHARGING TO A NON-SPECIAL/NON-IMPAIRED SURFACE WATER OR WETLAND.
b. A 100-FOOT NATURAL BUFFER WILL BE PRESERVED IN CONSTRUCTION AREAS DISCHARGING TO A SPECIAL OR IMPAIRED SURFACE WATER.
9. SEDIMENTATION TREATMENT CHEMICALS: NOT APPLICABLE.
10. TEMPORARY SEDIMENT BASIN(S): THE PROJECT WILL NOT INCLUDE 10 OR MORE ACRES OF DISTURBED SOIL DRAINING TO A COMMON LOCATION OR 5 OR MORE ACRES DRAINING TO A COMMON LOCATION WITHIN 1 MILE OR A SPECIAL OR IMPAIRED WATER THEREFORE TEMPORARY SEDIMENT BASINS ARE NOT REQUIRED.

4.3 DEWATERING AND BASIN DRAINING: (CSW PERMIT SECTION 10 AND ITEM 10.5)

- a. THE FOLLOWING WILL BE USED TO TREAT/DISPOSE OF TURBID OR SEDIMENT-LADEN WATER DURING DEWATERING OR BASIN DRAINING: IN-STREAM SILT FENCE, ROCK CHECKS, SEDIMENT FILTER BAGS OR EQUIVALENT MEASURES.
b. THE FOLLOWING WILL BE USED TO PREVENT EROSION OR SCOUR OF DISCHARGE POINTS DURING DEWATERING OR BASIN DRAINING: IN-STREAM SILT FENCE, ROCK CHECKS, SEDIMENT FILTER BAGS OR EQUIVALENT MEASURES.
c. NOT APPLICABLE: FILTERS FOR BACKWASH WATER

4.4 BMP DESIGN FACTORS: THE FOLLOWING BMP DESIGN FACTORS HAVE BEEN CONSIDERED IN DESIGNING THE TEMPORARY EROSION PREVENTION AND SEDIMENT CONTROL BMPS:

- 1. EXPECTED AMOUNT, FREQUENCY, INTENSITY, AND DURATION OF PRECIPITATION: APPROXIMATELY 2.5 INCHES OF PRECIPITATION FROM THE 1-YEAR, 24-HOUR STORM EVENT (NOAA ATLAS 14)
2. NATURE OF STORMWATER RUNOFF AND RUN-ON AT THE SITE, INCLUDING FACTORS SUCH AS EXPECTED FLOW FROM IMPERVIOUS SURFACES, SLOPES, AND SITE DRAINAGE FEATURES
3. STORMWATER VOLUME, VELOCITY, AND PEAK FLOW RATES TO MINIMIZE DISCHARGE OF POLLUTANTS IN STORMWATER AND TO MINIMIZE CHANNEL AND STREAMBANK EROSION AND SCOUR IN THE IMMEDIATE VICINITY OF DISCHARGE POINTS
4. RANGE OF SOIL PARTICLE SIZES EXPECTED TO BE PRESENT: CLAY, SANDY CLAY, SANDY SILT, SILTY SAND, SAND, GRAVEL.

4.5 BMP QUANTITIES: ANTICIPATED EROSION PREVENTION AND SEDIMENT CONTROL BMP QUANTITIES NEEDED FOR THE LIFE OF THE PROJECT: SEE PLANS AND SPECIFICATIONS/BID FORM

(SEE PAGE 2 OF 2)
50% DESIGN
NOT FOR CONSTRUCTION

CADD USER: GREG NELSON; FILE: M:\DESIGN\20271901_06\2027190100_SW06\02_SWPPP.DWG; PLOT SCALE: 1:2; PLOT DATE: 2/10/2022 2:40 PM

Table for revision tracking with columns: NO., BY, CHK., APP., DATE, REVISION DESCRIPTION

I HEREBY CERTIFY THAT THIS PLAN, SPECIFICATION, OR REPORT WAS PREPARED BY ME OR UNDER MY DIRECT SUPERVISION AND THAT I AM A DULY LICENSED PROFESSIONAL ENGINEER UNDER THE LAWS OF THE STATE OF MINNESOTA.
PRINTED NAME: _____
SIGNATURE: _____
DATE: _____ LICENSE # _____

Table for client and release information with columns: CLIENT, BID, CONSTRUCTION, RELEASED TO/FOR, DATE RELEASED

BARR logo and contact information: Corporate Headquarters: Minneapolis, Minnesota; Ph: 1-800-632-2277

Table for scale and approval with columns: Scale, AS SHOWN, Date, Drawn, Checked, Designed, Approved

CITY OF GOLDEN VALLEY GOLDEN VALLEY, MN
MEDLEY PARK STORMWATER IMPROVEMENT
STORM WATER POLUTION PREVENTION PLAN (SWPPP) PAGE 1 OF 2
BARR PROJECT No. 23/27-1901.00
CLIENT PROJECT No. 20-26
DWG. No. SW-01 REV. No. A

5.0 PERMANENT STORMWATER MANAGEMENT SYSTEM:

A PERMANANT STORMWATER MANAGEMENT SYSTEM IS REQUIRED IF THE PROJECT RESULTS IN ONE ACRE OR MORE OF NEW IMPERVIOUS SURFACES OR RESULTS IN A NET INCREASE OF ONE OR MORE ACRES OF CUMMULATIVE NEW IMPERVIOUS SURFACES IN TOTAL OR IF THE PROJECT IS PART OF A LARGER PLAN OF DEVELOPMENT. (CSW PERMIT ITEM 15.3)

5.1 A PERMANENT STORMWATER TREATMENT SYSTEM IS NOT REQUIRED. (CSW PERMIT ITEMS 5.15, 15.4-15.9, AND 23.14)

5.2 THIS IS NOT A LINEAR PROJECT WITH LACK OF RIGHT OR WAY. (CSW PERMIT ITEM 15.9)

5.3 THIS PROJECT DOES NOT DISCHARGE TO A TROUT STREAM (OR A TRIBUTARY TO A TROUT STREAM). (CSW PERMIT ITEM 23.12)

6.0 INSPECTION AND MAINTENANCE ACTIVITIES:

6.1 PERSONS WITH REQUIRED TRAINING: TRAINED INDIVIDUALS INCLUDE THOSE PARTIES RESPONSIBLE FOR INSTALLING, SUPERVISING, REPAIRING, INSPECTING, AND MAINTAINING EROSION PREVENTION AND SEDIMENT CONTROL BMPS AT THE SITE. TRAINED INDIVIDUALS ARE ALSO RESPONSIBLE FOR IMPLEMENTATION OF THE SWPPP AND COMPLIANCE WITH THE GENERAL PERMIT UNTIL THE CONSTRUCTION ACTIVITIES ARE COMPLETE, PERMANENT COVER HAS BEEN ESTABLISHED, AND A NOTICE OF TERMINATION (NOT) HAS BEEN SUBMITTED. (CSW PERMIT ITEMS 5.20, 5.21, AND 11.9 AND SECTION 21)

THESE INDIVIDUALS WILL BE TRAINED IN ACCORDANCE WITH THE REQUIREMENTS OF THE GENERAL PERMIT, INCLUDING THE REQUIREMENT THAT THE CONTENT AND EXTENT OF TRAINING WILL BE COMMENSURATE WITH THE INDIVIDUAL'S JOB DUTIES AND RESPONSIBILITIES.

BELOW IS A LIST OF PEOPLE RESPONSIBLE FOR THIS PROJECT WHO ARE KNOWLEDGEABLE AND EXPERIENCED IN THE APPLICATION OF EROSION PREVENTION AND SEDIMENT CONTROL BMPS.

TRAINED INDIVIDUAL	RESPONSIBILITY	TRAINING ENTITY*	TRAINING DATE
ALEC BATEMAN	PREPARATION OF THE SWPPP	UNIVERSITY OF MINNESOTA	APRIL, 2021
TBD	OVERSIGHT OF SWPPP IMPLEMENTATION, REVISION, AND AMMENDMENT	TBD	TBD
TBD	PERFORMANCE OF SWPPP INSPECTIONS	TBD	TBD
TBD	PERFORMANCE OR SUPERVISION OF INSTALLATION, MAINTENANCE, AND REPAIR OF BMPS	TBD	TBD

*TRAINING DOCUMENTATION AVAILABLE UPON REQUEST.

6.2 FREQUENCY OF INSPECTIONS: A TRAINED PERSON WILL ROUTINELY INSPECT THE ENTIRE CONSTRUCTION SITE. (CSW PERMIT ITEMS 11.2, 11.10, AND 23.13)

- AT LEAST ONCE EVERY 7 DAYS DURING ACTIVE CONSTRUCTION
- WITHIN 24 HOURS AFTER A RAINFALL EVENT GREATER THAN 0.5 INCHES IN 24 HOURS

INSPECTION FREQUENCY MAY BE ADJUSTED UNDER THE FOLLOWING CIRCUMSTANCES:

- WHERE PARTS OF THE CONSTRUCTION AREAS HAVE PERMANENT COVER, BUT WORK REMAINS ON OTHER PARTS OF THE SITE, INSPECTIONS OF THE AREAS WITH PERMANENT COVER MAY BE REDUCED TO ONCE PER MONTH.
- WHERE CONSTRUCTION AREAS HAVE PERMANENT COVER AND NO CONSTRUCTION ACTIVITY IS OCCURRING ON THE SITE, INSPECTIONS CAN BE REDUCED TO ONCE PER MONTH AND, AFTER 12 MONTHS, MAY BE SUSPENDED COMPLETELY UNTIL CONSTRUCTION ACTIVITY RESUMES.
- WHERE CONSTRUCTION ACTIVITY HAS BEEN SUSPENDED DUE TO FROZEN GROUND CONDITIONS, THE INSPECTIONS MAY BE SUSPENDED. THE REQUIRED INSPECTIONS AND MAINTENANCE SCHEDULE MUST BEGIN WITHIN 24 HOURS AFTER RUNOFF OCCURS AT THE SITE OR UPON RESUMING CONSTRUCTION, WHICHEVER COMES FIRST.

6.3 INSPECTION REQUIREMENTS: EACH CONSTRUCTION STORMWATER SITE INSPECTION WILL INCLUDE INSPECTION OF THE FOLLOWING AREAS: (CSW PERMIT ITEMS 11.3 THROUGH 11.8)

- ALL EROSION PREVENTION AND SEDIMENT CONTROL BMPS AND POLLUTION PREVENTION MANAGEMENT MEASURES
- SURFACE WATERS FOR EVIDENCE OF EROSION AND SEDIMENT DEPOSITION
- CONSTRUCTION SITE VEHICLE EXIT LOCATIONS FOR EVIDENCE OF OFFSITE SEDIMENT TRACKING
- STREETS AND OTHER AREAS ADJACENT TO THE PROJECT FOR EVIDENCE OF OFF SITE ACCUMULATIONS OF SEDIMENT

6.4 MAINTENANCE REQUIREMENTS: MAINTENANCE OF THE FOLLOWING AREAS AND BMPS WILL BE PERFORMED AS FOLLOWS: (CSW PERMIT ITEMS 11.3 THROUGH 11.8)

- NONFUNCTIONAL BMPS WILL BE REPAIRED, REPLACED, OR SUPPLEMENTED WITH FUNCTIONAL BMPS BY THE END OF THE NEXT BUSINESS DAY AFTER DISCOVERY OR AS SOON AS FIELD CONDITIONS ALLOW ACCESS.
- PERIMETER CONTROL DEVICES WILL BE REPAIRED, REPLACED, OR SUPPLEMENTED WHEN THEY BECOME NONFUNCTIONAL OR THE SEDIMENT REACHES 1/2 OF THE HEIGHT OF THE DEVICE.
- TEMPORARY AND PERMANENT SEDIMENTATION BASINS WILL BE DRAINED AND THE SEDIMENT REMOVED WHEN THE DEPTH OF SEDIMENT COLLECTED IN THE BASIN REACHES 1/2 THE STORAGE VOLUME.
- DELTA AND SEDIMENT DEPOSITED IN SURFACE WATERS WILL BE REMOVED, AND THE AREAS WHERE SEDIMENT REMOVAL RESULTS IN EXPOSED SOIL WILL BE RE-STABILIZED. THE REMOVAL AND STABILIZATION WILL BE COMPLETED WITHIN 7 CALENDAR DAYS OF DISCOVERY UNLESS PRECLUDED BY LEGAL, REGULATORY, OR PHYSICAL ACCESS CONSTRAINTS. IF PRECLUDED DUE TO ACCESS CONSTRAINTS, REASONABLE EFFORTS TO OBTAIN ACCESS WILL BE USED. REMOVAL AND STABILIZATION WILL TAKE PLACE WITHIN 7 CALENDAR DAYS OF OBTAINING ACCESS.
- TRACKED SEDIMENT ON PAVED SURFACES WILL BE REMOVED WITHIN 1 CALENDAR DAY OF DISCOVERY.
- AREAS UNDERGOING STABILIZATION WILL BE RESTABILIZED AS NECESSARY TO ACHIEVE REQUIRED COVER.

6.5 RECORDKEEPING REQUIREMENTS: (CSW PERMIT ITEMS 11.11 AND 24.5 AND SECTIONS 6 AND 20)

- ALL INSPECTIONS AND MAINTENANCE ACTIVITIES WILL BE RECORDED IN WRITING WITHIN 24 HOURS OF BEING CONDUCTED AND THESE RECORDS WILL BE RETAINED WITH THE SWPPP. RECORDS OF EACH INSPECTION AND MAINTENANCE ACTIVITY WILL INCLUDE THE DATE AND TIME; NAME OF INSPECTOR(S); FINDINGS OF INSPECTIONS; CORRECTIVE ACTIONS (INCLUDING DATES, TIMES, AND PARTY COMPLETING MAINTENANCE ACTIVITIES); AND

DATE OF ALL RAINFALL EVENTS GREATER THAN 0.5 INCHES IN 24 HOURS AND THE AMOUNT OF RAINFALL FOR EACH EVENT.

- IF ANY DISCHARGE IS OBSERVED DURING THE INSPECTION, THE LOCATION AND APPEARANCE OF THE DISCHARGE (I.E., COLOR, ODOR, SETTLED OR SUSPENDED SOLIDS, OIL SHEEN, AND OTHER OBVIOUS INDICATORS OF POLLUTANTS) WILL BE DOCUMENTED AND A PHOTOGRAPH WILL BE TAKEN.
- THE SWPPP WILL BE AMENDED TO INCLUDE ADDITIONAL OR MODIFIED BMPS TO CORRECT PROBLEMS OR ADDRESS SITUATIONS WHENEVER THERE IS A CHANGE IN DESIGN, CONSTRUCTION, OPERATION, MAINTENANCE, WEATHER, OR SEASONAL CONDITIONS THAT HAS A SIGNIFICANT EFFECT ON THE DISCHARGE OF POLLUTANTS TO SURFACE WATERS OR GROUNDWATER.
 - THE SWPPP WILL BE AMENDED WHEN INSPECTIONS OR INVESTIGATIONS BY THE SITE OWNER, OPERATOR, OR CONTRACTORS OR BY USEPA/MPCA OFFICIALS INDICATE THAT THE SWPPP IS NOT EFFECTIVE IN ELIMINATING OR MINIMIZING THE DISCHARGE OF POLLUTANTS TO SURFACE WATERS OR GROUNDWATER; THE DISCHARGES ARE CAUSING WATER QUALITY STANDARD EXCEEDANCES; OR THE SWPPP IS NOT CONSISTENT WITH A USEPA APPROVED TMDL.
 - ANY AMENDMENTS TO THE SWPPP PROPOSED AS A RESULT OF THE INSPECTION WILL BE DOCUMENTED AS REQUIRED WITHIN 7 CALENDAR DAYS.
 - AMENDMENTS WILL BE COMPLETED BY AN APPROPRIATELY TRAINED INDIVIDUAL. CHANGES INVOLVING THE USE OF A LESS STRINGENT BMP WILL INCLUDE A JUSTIFICATION DESCRIBING HOW THE REPLACEMENT BMP IS EFFECTIVE FOR THE SITE CHARACTERISTICS.
 - RECORDS RETENTION: THE SWPPP, INCLUDING ALL CHANGES TO IT, AND INSPECTION AND MAINTENANCE RECORDS WILL BE KEPT AT THE SITE DURING CONSTRUCTION BY THE PERMITEE WHO HAS OPERATIONAL CONTROL OF THE SITE. THE SWPPP CAN BE KEPT IN EITHER A FIELD OFFICE OR IN AN ON SITE VEHICLE DURING NORMAL WORKING HOURS.
 - RECORD AVAILABILITY: THE PERMITEES WILL MAKE THE SWPPP, INCLUDING INSPECTION REPORTS, MAINTENANCE RECORDS, AND TRAINING RECORDS, AVAILABLE TO FEDERAL, STATE, AND LOCAL OFFICIALS WITHIN THREE DAYS UPON REQUEST FOR THE DURATION OF THE PERMIT COVERAGE AND FOR THREE YEARS FOLLOWING THE NOTICE OF TERMINATION.

7.0 POLLUTION PREVENTION MEASURES:


- ANY CONSTRUCTION PRODUCTS AND LANDSCAPE MATERIALS THAT HAVE THE POTENTIAL TO LEACH POLLUTANTS WILL BE STORED UNDER COVER (E.G., PLASTIC SHEETING OR TEMPORARY ROOFS) TO PREVENT DISCHARGE OF POLLUTANTS THROUGH MINIMIZATION OF CONTACT WITH STORMWATER. STORAGE OF SUCH MATERIALS WITHIN THE PROJECT AREA WILL BE MINIMIZED TO THE EXTENT POSSIBLE. (CSW PERMIT ITEM 12.2)
- PESTICIDES, FERTILIZERS, AND TREATMENT CHEMICALS WILL BE STORED UNDER COVER (E.G., PLASTIC SHEETING, TEMPORARY ROOFS, WITHIN A BUILDING, OR IN WEATHER-PROOF CONTAINERS) TO PREVENT DISCHARGE OF POLLUTANTS THROUGH MINIMIZATION OF CONTACT WITH STORMWATER. STORAGE OF SUCH MATERIALS WITHIN THE PROJECT AREA WILL BE MINIMIZED TO THE EXTENT POSSIBLE. (CSW PERMIT ITEM 12.3)
- HAZARDOUS MATERIALS AND TOXIC WASTE (E.G., OIL, DIESEL FUEL, GASOLINE, HYDRAULIC FLUIDS, PAINT SOLVENTS, PETROLEUM-BASED PRODUCTS, WOOD PRESERVATIVES, ADDITIVES, CURING COMPOUNDS, AND ACIDS) WILL BE STORED AND DISPOSED OF IN COMPLIANCE WITH MINNESOTA RULES CHAPTER 7045, INCLUDING SECONDARY CONTAINMENT (AS APPLICABLE). HAZARDOUS MATERIALS WILL BE PROPERLY STORED IN SEALED CONTAINERS TO PREVENT SPILLS, LEAKS, OR OTHER DISCHARGES AND PREVENT PRECIPITATION FROM FALLING ONTO THE CONTAINERS OR STORED HAZARDOUS MATERIALS. (CSW PERMIT ITEMS 2.3 AND 12.4)
- SOLID WASTE WILL BE COLLECTED, STORED, AND DISPOSED OF PROPERLY IN COMPLIANCE WITH MINNESOTA RULES CHAPTER 7035. THIS INCLUDES STORAGE WITHIN COVERED TRASH CONTAINERS AND DAILY REMOVAL OF LITTER AND DEBRIS. STORAGE OF SOLID WASTE WITHIN THE PROJECT AREA WILL BE MINIMIZED TO THE EXTENT POSSIBLE. (CSW PERMIT ITEM 12.5)
- PORTABLE TOILETS WILL BE LOCATED AWAY FROM SURFACE WATERS AND POSITIONED AND SECURED TO THE GROUND SO THEY WILL NOT BE TIPPED OR KNOCKED OVER. SANITARY WASTE WILL BE DISPOSED OF IN ACCORDANCE WITH MINNESOTA RULES, CHAPTER 7041. PORTABLE TOILETS WILL BE PERIODICALLY EMPTIED AND THE WASTE HAULED OFF-SITE BY A LICENSED HAULER. (CSW PERMIT ITEM 12.6)
- VEHICLE FUELING WILL ONLY OCCUR IN DESIGNATED AREAS. SPILL KITS SIZED APPROPRIATELY FOR THE AMOUNT OF REFUELING TAKING PLACE WILL BE LOCATED. SPILL KITS WILL BE CLEARLY LABELED AND CONTAIN MATERIALS TO ASSIST IN SPILL CLEANUP INCLUDING ABSORBENT PADS, BOOMS FOR CONTAINING SPILLS, AND HEAVY-DUTY PROTECTIVE GLOVES. SPILLS WILL BE REPORTED TO THE MINNESOTA DUTY OFFICER AS REQUIRED BY MINNESOTA STATUTES, SECTION 115.061. (CSW PERMIT ITEMS 2.3 AND 12.7)
 - ANY FUEL TANKS BROUGHT ON-SITE WILL HAVE PROPERLY SIZED CONTAINMENT AND WILL NOT BE TOPPED OFF TO AVOID SPILLS FROM OVERFILLING. FUEL TANKS WILL MEET INDUSTRY STANDARDS (DESIGNED TO HOLD FUEL TYPE, PROPERLY MAINTAINED, NOT ILLEGALLY MODIFIED, NOT MISSING LEAK INDICATOR FLOATS FOR DOUBLE WALLED TANKS, SIGHT GAUGES NOT USED, ETC.) OR BE REMOVED FROM THE WORK AREA.
 - GUIDELINES FOR SPILL PREVENTION AND RESPONSE INCLUDE:
 - TAKE REASONABLE STEPS TO PREVENT THE DISCHARGE OF SPILLED OR LEAKED CHEMICALS, INCLUDING FUEL, FROM ANY AREA WHERE CHEMICALS OR FUEL WILL BE LOADED OR UNLOADED, INCLUDING THE USE OF DRIP PANS OR ABSORBENTS UNLESS INFEASIBLE;
 - PERFORM REGULAR PREVENTATIVE MAINTENANCE ON TANKS AND FUEL LINES;
 - INSPECT PUMPS, CYLINDERS, HOSES, VALVES, AND OTHER MECHANICAL EQUIPMENT ON-SITE FOR DAMAGE OR DETERIORATION;
 - DO NOT WASH OR RINSE FUELING AREAS WITH WATER;
 - MAINTAIN ADEQUATE SUPPLIES TO CLEAN UP DISCHARGED MATERIALS AND PROVIDE AN APPROPRIATE DISPOSAL METHOD FOR RECOVERED SPILLED MATERIALS;
 - REPORT AND CLEAN UP SPILLS IMMEDIATELY AS REQUIRED BY MINNESOTA STATUTES, SECTION 115.061, USING DRY CLEAN UP MEASURES WHERE POSSIBLE; AND
 - MAINTAIN COPIES OF SAFETY DATA SHEETS (SDSS) FOR HAZARDOUS MATERIALS ON-SITE IN LOCATIONS READILY AVAILABLE TO EMERGENCY RESPONDERS.
- IF VEHICLE AND EQUIPMENT WASHING IS NECESSARY, A VEHICLE WASH STATION WILL BE LOCATED IN A DESIGNATED AREA. RUNOFF FROM THE WASHING AREA WILL BE CONTAINED IN A SEDIMENT BASIN AND WASTE FROM THE WASHING ACTIVITY WILL BE PROPERLY DISPOSED OF. ANY SOAPS, DETERGENTS, OR SOLVENTS WILL BE PROPERLY USED AND STORED. ANY DETERGENTS AND OTHER CLEANERS NOT PERMITTED FOR DISCHARGE WILL NOT BE USED. (CSW PERMIT ITEMS 2.3 AND 12.8)
- THE PROJECT WILL NOT RESULT IN CONCRETE OR OTHER WASHOUT ACTIVITIES. IF NECESSARY, A DESCRIPTION OF THE STORAGE AND DISPOSAL OF CONCRETE AND OTHER WASHOUT WASTES SO THAT WASTES DO NOT CONTACT THE GROUND WILL BE ADDED. (CSW PERMIT ITEMS 2.3 AND 12.9)

8.0 PERMANENT COVER AND PERMIT TERMINATION CONDITIONS:

- THE AREAS DISTURBED DURING CONSTRUCTION WILL BE STABILIZED WITH PERMANENT COVER UPON COMPLETION OF WORK. PERMANENT COVER MAY BE VEGETATIVE OR NON-VEGETATIVE, AS APPROPRIATE. ESTABLISHMENT OF PERMANENT COVER MAY INCLUDE THE FOLLOWING ACTIVITIES: A COMBINATION OF SEEDING, MULCHING, EROSION CONTROL BLANKETS, AND/OR PLACEMENT OF IMPERVIOUS SURFACES. (CSW PERMIT ITEM 5.17)
- FOR A CONSTRUCTION-SITE TO ACHIEVE "PERMANENT COVER", THE FOLLOWING REQUIREMENTS MUST BE

COMPLETED PRIOR TO TERMINATION OF PERMIT COVERAGE: (CSW PERMIT SECTIONS 4 AND 13)

- ALL SOIL DISTURBING CONSTRUCTION ACTIVITIES HAVE BEEN COMPLETED AND PERMANENT COVER HAS BEEN INSTALLED OVER ALL AREAS. VEGETATIVE COVER CONSISTS OF A UNIFORM PERENNIAL VEGETATION WITH A DENSITY OF 70% OF ITS EXPECTED FINAL GROWTH. VEGETATION IS NOT REQUIRED WHERE THE FUNCTION OF A SPECIFIC AREA DICTATES NO VEGETATION (SUCH AS IMPERVIOUS SURFACES OR THE BASE OF A SAND FILTER).
 - ALL SEDIMENT HAS BEEN REMOVED FROM CONVEYANCE SYSTEMS, INCLUDING CULVERTS.
 - ALL TEMPORARY SYNTHETIC EROSION PREVENTION AND SEDIMENT CONTROL BMPS HAVE BEEN REMOVED. BMPS DESIGNED TO DECOMPOSE ON-SITE MAY BE LEFT IN PLACE.
- WITHIN 30 DAYS AFTER THE TERMINATION CONDITIONS ARE COMPLETE, A NOTICE OF TERMINATION (NOT) FORM WILL BE SUBMITTED TO THE MPCA.

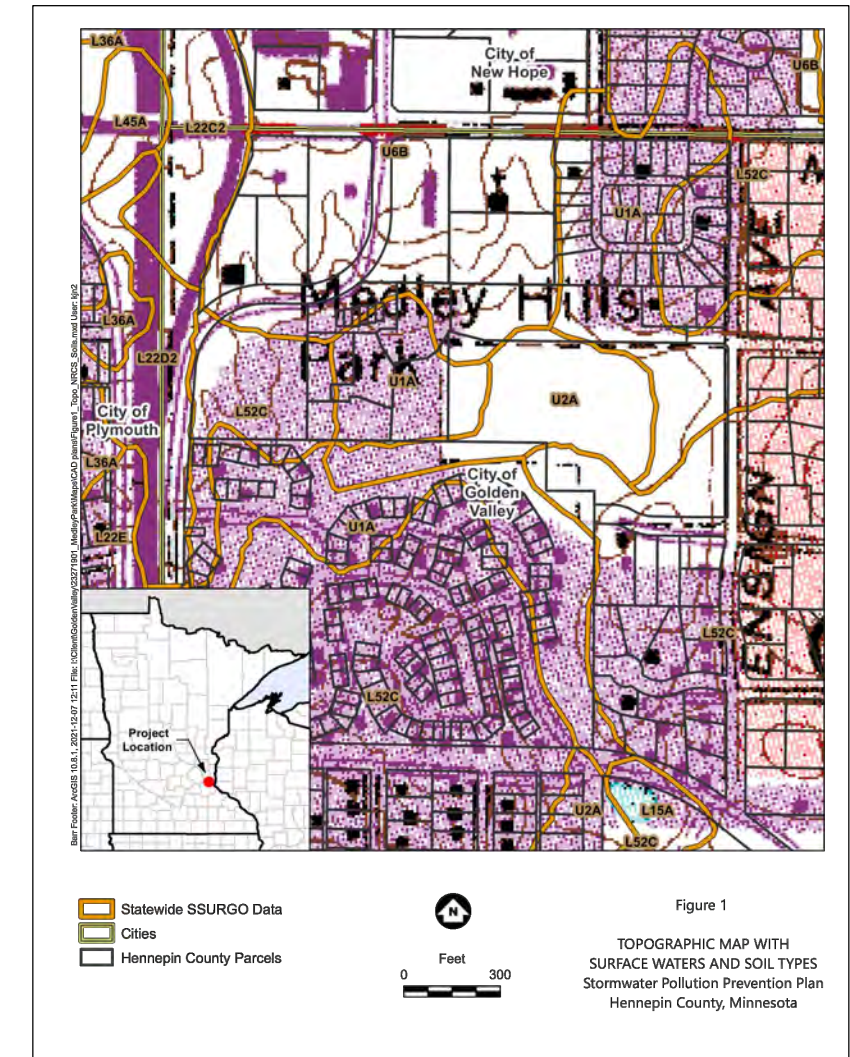

50% DESIGN
NOT FOR CONSTRUCTION

I HEREBY CERTIFY THAT THIS PLAN, SPECIFICATION, OR REPORT WAS PREPARED BY ME OR UNDER MY DIRECT SUPERVISION AND THAT I AM A DULY LICENSED PROFESSIONAL ENGINEER UNDER THE LAWS OF THE STATE OF MINNESOTA.		CLIENT BID CONSTRUCTION	12/10/21							
PRINTED NAME		RELEASED TO/FOR		A	B	C	0	1	2	3
SIGNATURE		DATE		DATE RELEASED						
NO.	BY	CHK.	APP.	DATE	REVISION DESCRIPTION					
A	ADB2	KJN2	KAL	12/10/2021	ISSUED FOR REVIEW					


CLIENT	12/10/21									
BID										
CONSTRUCTION										
RELEASED TO/FOR	A	B	C	0	1	2	3			
DATE RELEASED										

BARR golden valley
 Corporate Headquarters: Minneapolis, Minnesota
 Ph: 1-800-632-2277


Scale	AS SHOWN
Date	12/10/2021
Drawn	ADB2
Checked	KJN2
Designed	BARR
Approved	KAL

CITY OF GOLDEN VALLEY
GOLDEN VALLEY, MN


MEDLEY PARK STORMWATER IMPROVEMENT		BARR PROJECT No. 23/27-1901.00
STORM WATER POLUTION PREVENTION PLAN (SWPPP) PAGE 2 OF 2		CLIENT PROJECT No. 20-26
DWG. No. SW-02	REV. No. A	

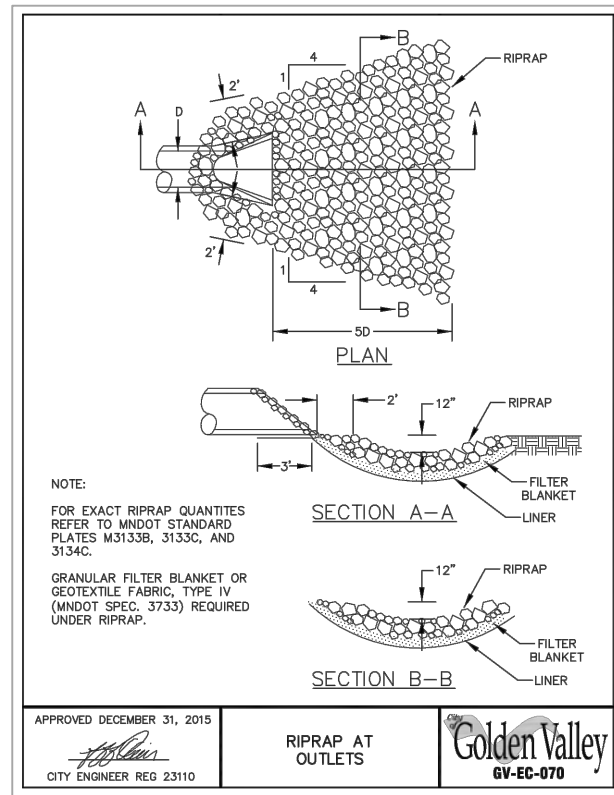


1 DETAIL: RIPRAP AT OUTLETS
NOT TO SCALE

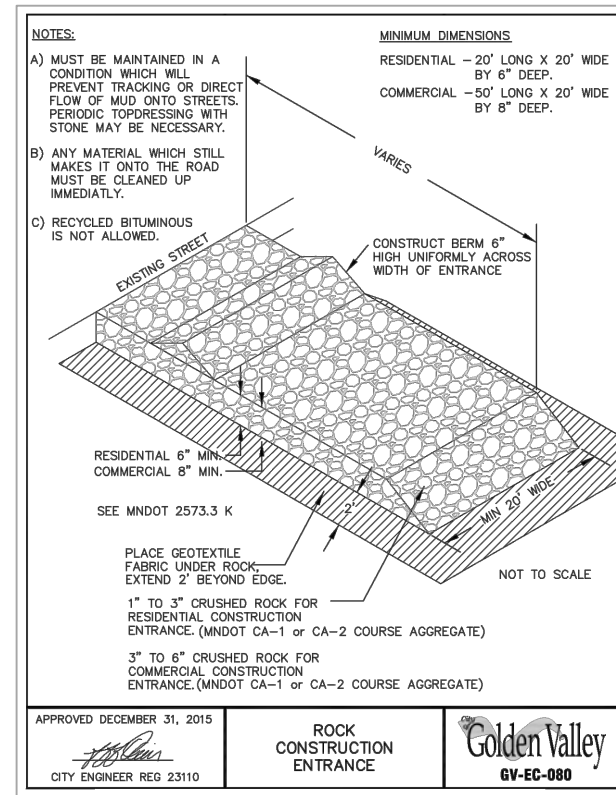


2 DETAIL: ROCK CONSTRUCTION ENTRANCE
NOT TO SCALE

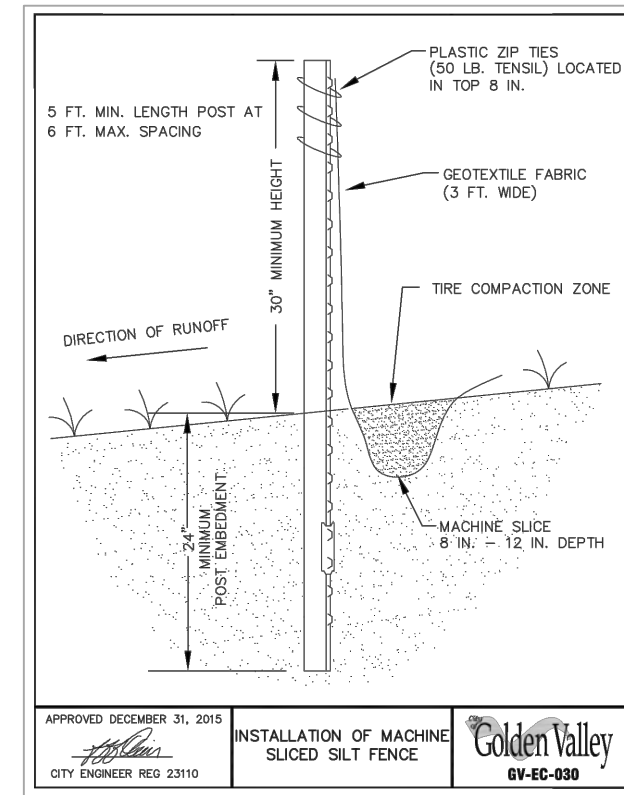


3 DETAIL: MACHINE SLICED SILT FENCE
NOT TO SCALE

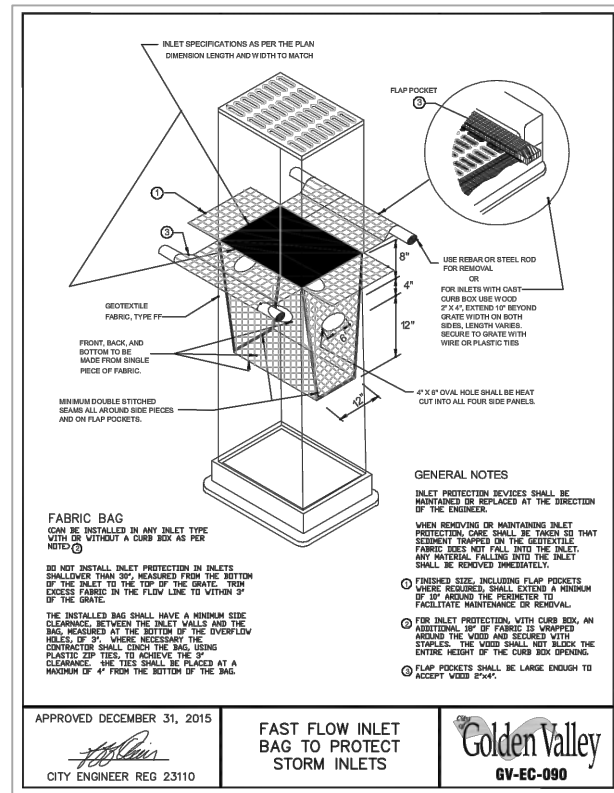

4 DETAIL: INLET PROTECTION
NOT TO SCALE

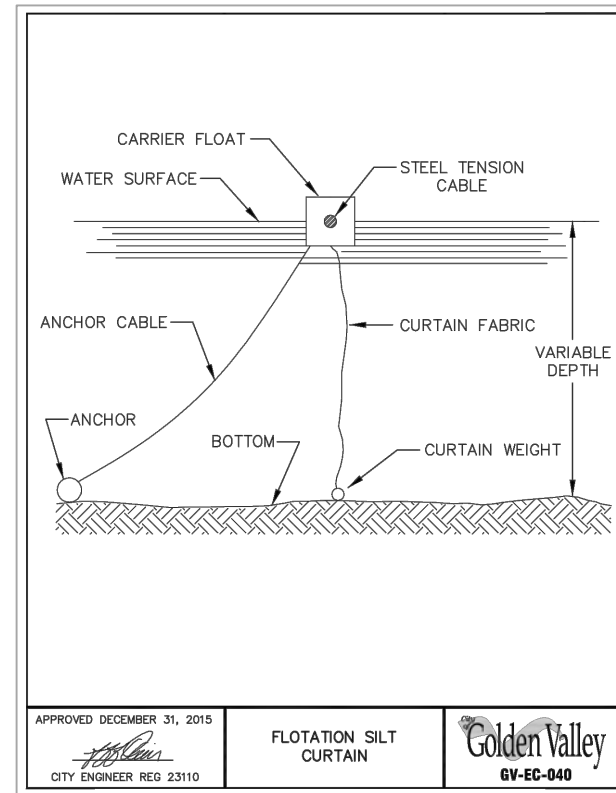

5 DETAIL: FLOTATION SILT CURTAIN
NOT TO SCALE

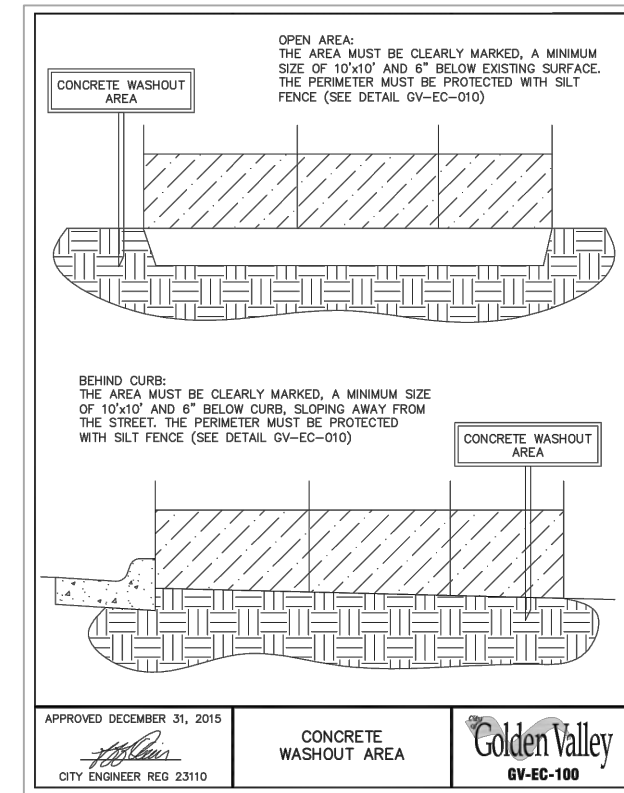


6 DETAIL: CONCRETE WASHOUT AREA
NOT TO SCALE

CADD USER: Greg Nelson FILE: I:\DESIGN\23271901_00\23271901_00_S\03_EROSION CONTROL DETAILS.DWG PLOT SCALE: 1/2" = 1'-0" PLOT DATE: 2/11/2022 2:21 PM

I HEREBY CERTIFY THAT THIS PLAN, SPECIFICATION, OR REPORT WAS PREPARED BY ME OR UNDER MY DIRECT SUPERVISION AND THAT I AM A DULY LICENSED PROFESSIONAL ENGINEER UNDER THE LAWS OF THE STATE OF MINNESOTA.				CLIENT BID CONSTRUCTION	1/2/2021					 Corporate Headquarters: Minneapolis, Minnesota Ph: 1-800-632-2277	Scale Date Drawn Checked Designed Approved	AS SHOWN 12/10/2021 ADB2 KJN2 BARR KAL	CITY OF GOLDEN VALLEY GOLDEN VALLEY, MN	MEDLEY PARK STORMWATER IMPROVEMENT EROSION & SEDIMENT CONTROL DETAILS	BARR PROJECT No. 23/27-1901.00
NO.	BY	CHK.	APP.	DATE	REVISION DESCRIPTION	RELEASED TO/FOR	A	B	C		0	1			2
PRINTED NAME: _____ SIGNATURE: _____ DATE: _____ LICENSE #: _____															
DWG. No. SW-03 REV. No. A															


50% DESIGN
NOT FOR CONSTRUCTION

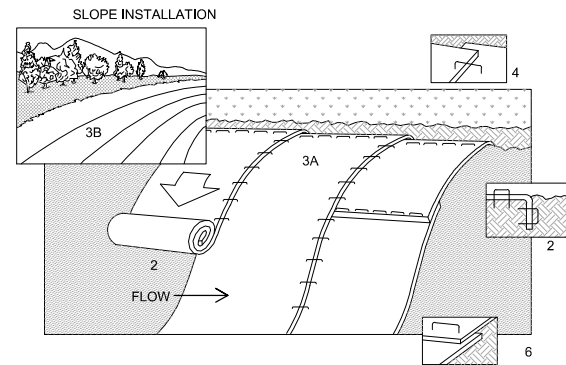

NOTES:

1. REFER TO MANUFACTURER RECOMMENDATIONS FOR STAPLE PATTERNS FOR SLOPE INSTALLATIONS.
2. PREPARE SOIL BY LOOSENING TOP 1-2 INCHES AND APPLY SEED (AND FERTILIZER WHERE REQUIRED) PRIOR TO INSTALLING BLANKETS. GROUND SHOULD BE SMOOTH AND FREE OF DEBRIS.
3. BEGIN (A) AT THE TOP OF THE SLOPE AND ROLL THE BLANKETS DOWN OR (B) AT ONE END OF THE SLOPE AND ROLL THE BLANKETS HORIZONTALLY ACROSS THE SLOPE.
4. THE EDGES OF PARALLEL BLANKETS MUST BE STAPLED WITH APPROXIMATELY 6" OVERLAP, WITH THE UPHILL BLANKET ON TOP.
5. WHEN BLANKETS MUST BE SPLICED DOWN THE SLOPE, PLACE BLANKETS END OVER END (SHINGLE STYLE) WITH APPROXIMATELY 6" OVERLAP. STAPLE THROUGH OVERLAPPED AREA, APPROXIMATELY 12" APART.
6. BLANKET MATERIALS SHALL BE AS SPECIFIED OR AS APPROVED BY ENGINEER.

1 DETAIL: EROSION CONTROL BLANKET - INSTALLATION
NOT TO SCALE

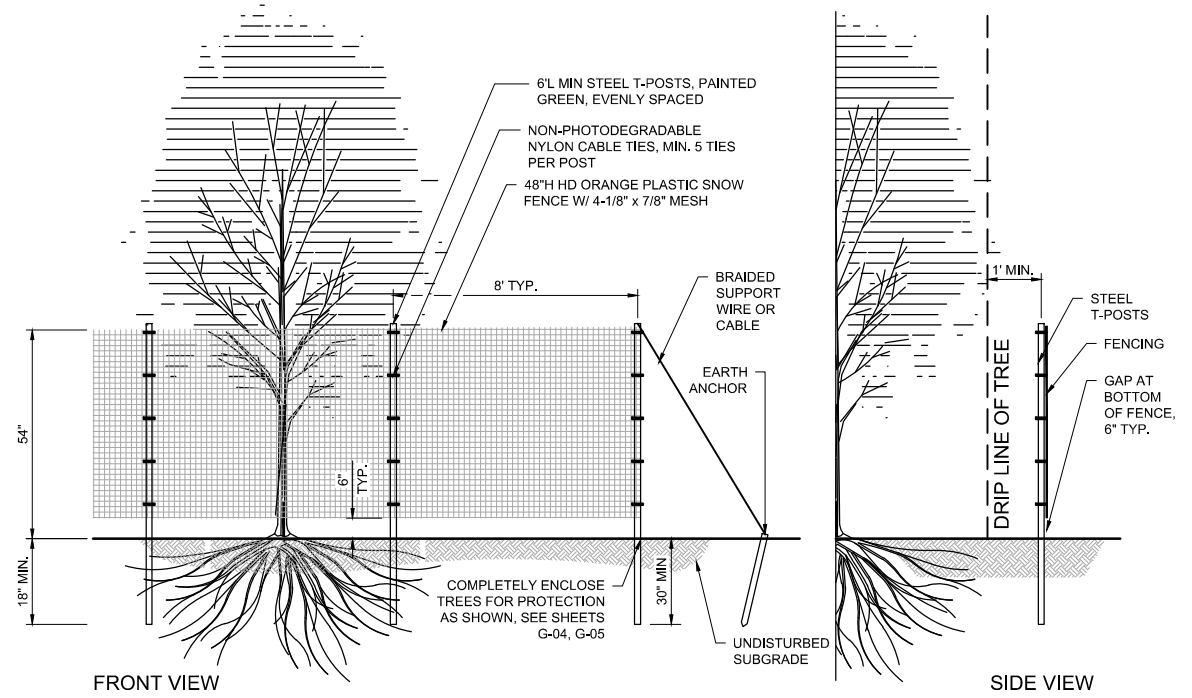

NOTES:

1. ENSURE FENCE IS PULLED TAUGHT BETWEEN POSTS AND ANCHOR SECURELY AS SHOWN. ENSURE CABLE TIES ARE PULLED TAUGHT AGAINST POST TO PREVENT SLIPPING.
2. PROVIDE 6" TYP. SPACE AT BOTTOM OF FENCE AS SHOWN TO PREVENT SMALL ANIMAL ENTRAPMENT IN FENCED AREA.
3. ENSURE CABLE TIES ARE EXTREME WEATHER COLD TEMPERATURE UV STABILIZED TIES.
4. T-POSTS SHALL BE STUDDED FOR CABLE TIE ATTACHMENT.
5. INSPECT FENCE REGULARLY AND REPAIR TO MAINTAIN OR REPLACE AS NECESSARY THROUGHOUT THE TERM OF THE PROJECT.

2 DETAIL: TREE PROTECTION FENCE
NOT TO SCALE





50% DESIGN
NOT FOR CONSTRUCTION

CADD USER: Greg Nelson FILE: I:\DESIGN\23271901_00\23271901_00_SW04_EROSION CONTROL DETAILS.DWG PLOT SCALE: 1:2 PLOT DATE: 2/11/2022 2:22 PM

I HEREBY CERTIFY THAT THIS PLAN, SPECIFICATION, OR REPORT WAS PREPARED BY ME OR UNDER MY DIRECT SUPERVISION AND THAT I AM A DULY LICENSED PROFESSIONAL ENGINEER UNDER THE LAWS OF THE STATE OF MINNESOTA.				CLIENT				12/10/21				 Corporate Headquarters: Minneapolis, Minnesota Ph: 1-800-632-2277	Scale		AS SHOWN		MEDLEY PARK STORMWATER IMPROVEMENT EROSION & SEDIMENT CONTROL DETAILS		BARR PROJECT No.		23/27-1901.00	
				CONSTRUCTION									Date		12/10/2021				CLIENT PROJECT No.		20-26	
PRINTED NAME: _____ SIGNATURE: _____ DATE: _____ LICENSE # _____				RELEASED TO/FOR				DATE RELEASED				Checked		KJN2		DWG. No.		REV. No.				
NO. BY CHK. APP. DATE REVISION DESCRIPTION				A B C 0 1 2 3				Designed		BARR		Approved		KAL		SW-04		A				

CITY OF GOLDEN VALLEY
GOLDEN VALLEY, MN

CADD USER: Greg Nelson FILE: I:\DESIGN\23271901_00\23271901_00_SOIL BORINGS_SED LOGS.DWG PLOT SCALE: 1:2 PLOT DATE: 2/1/2022 2:38 PM

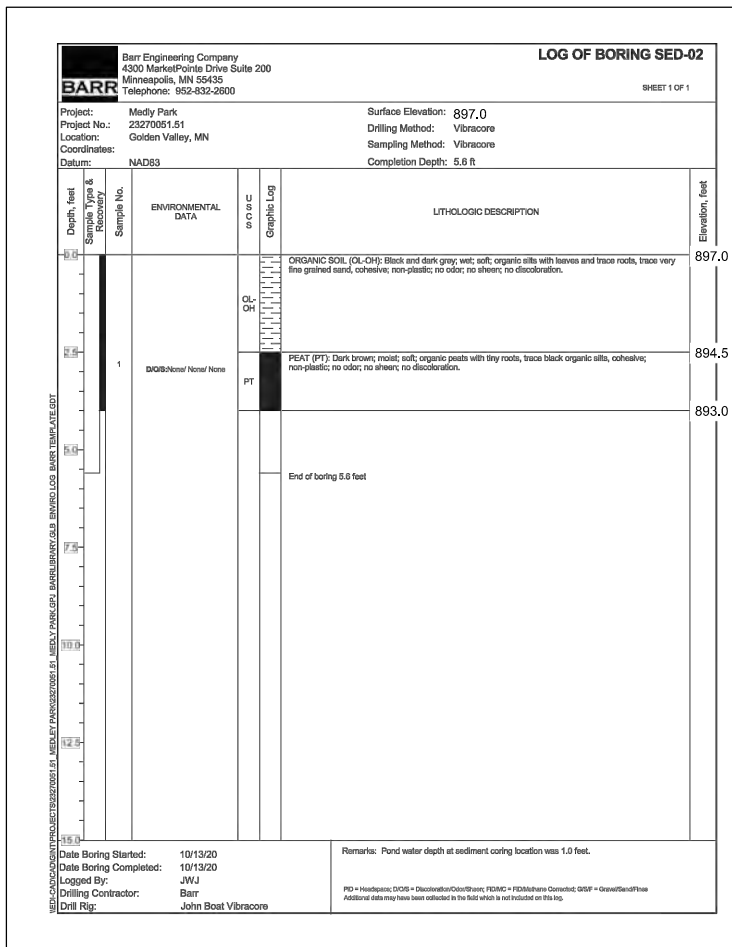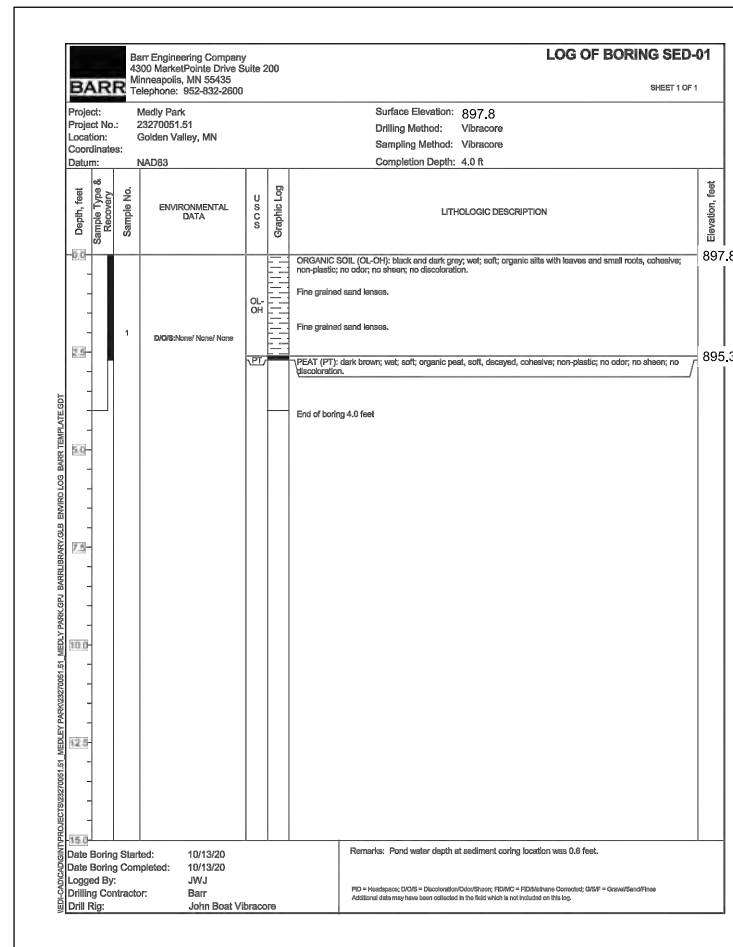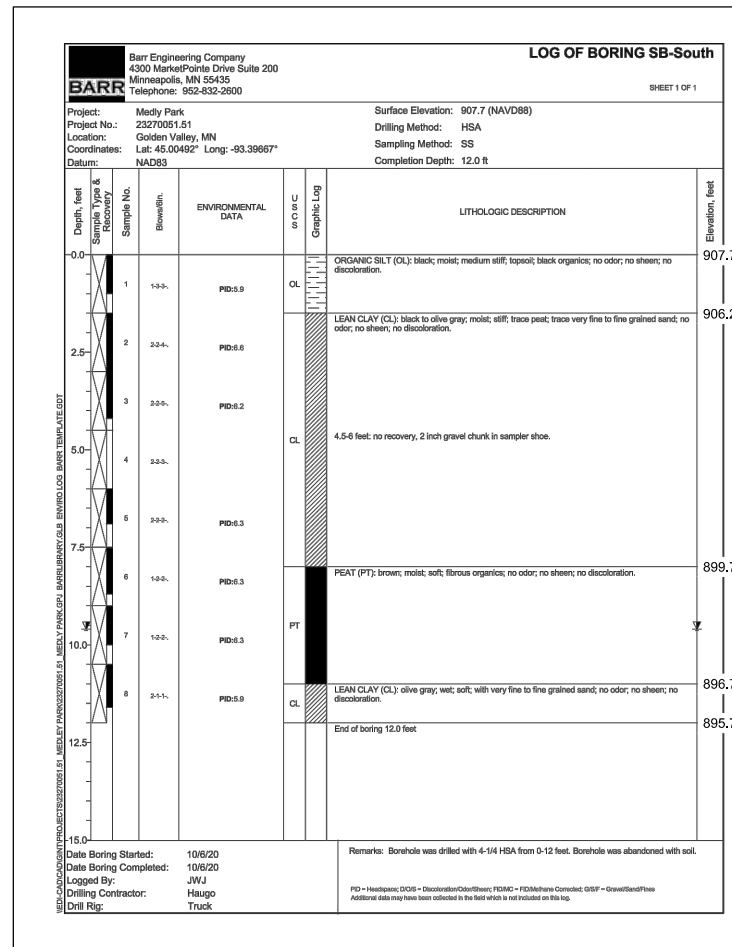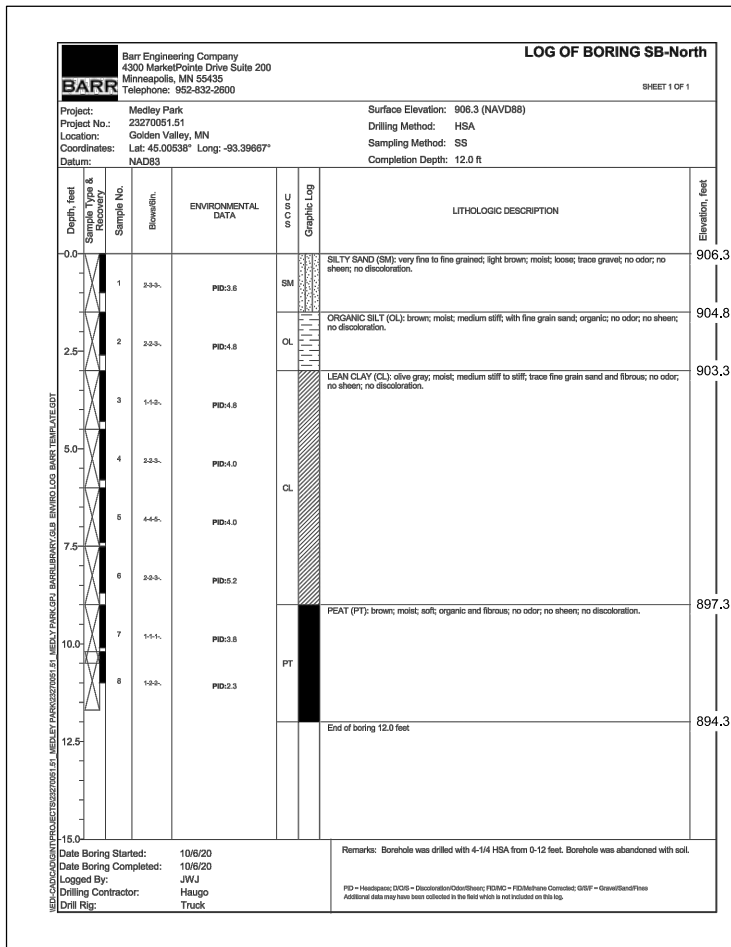

NOTE:
1) SEE SHEET C-01 FOR SOIL BORING LOCATIONS

50% DESIGN
NOT FOR CONSTRUCTION

I HEREBY CERTIFY THAT THIS PLAN, SPECIFICATION, OR REPORT WAS PREPARED BY ME OR UNDER MY DIRECT SUPERVISION AND THAT I AM A DULY LICENSED PROFESSIONAL ENGINEER UNDER THE LAWS OF THE STATE OF MINNESOTA.				CLIENT 2/2/2021				Scale AS SHOWN				BARR PROJECT No. 23/27-1901.00			
PRINTED NAME				RELEASED TO/FOR				Date 12/10/2021				CLIENT PROJECT No. 20-26			
SIGNATURE				DATE RELEASED				Drawn BARR				DWG. No. B-01			
DATE				DATE RELEASED				Checked KJN2				REV. No. A			
REVISION DESCRIPTION				DATE RELEASED				Designed BARR							
								Approved KAL							



CITY OF GOLDEN VALLEY
GOLDEN VALLEY, MN

MEDLEY PARK
STORMWATER IMPROVEMENT
SOIL BORINGS AND SEDIMENT LOGS